		DRA	WING II	NDEX	1
No:	Title	Rev:	Creation Date:	Revision Comment:	Date Modified:
S278/38/01	Alternative Methods of Laying Kerbs	С	31.05.2012	Carriageway reinstatement requirements added	25.04.2017
S278/38/02	Approved Kerb Type Selection Sheet 1	В	31.05.2012	Drain kerb added	25.04.2017
S278/38/03	Approved Kerb Type Selection Sheet 2	Α	31.05.2012	Corrected ref to CS1	28.02.2013
S278/38/04	Footway/Cycleway Type 1 & 2	В	31.05.2012	Tactile paving types added	09.09.2013
S278/38/05	Footway/Cycleway Type 3 & 4	С	31.05.2012	Footway Width increased to 2m	13.05.2014
S278/38/06	Public Footpath (Rural) Type 5	Α	31.05.2012	Notes amended	13.05.2014
5278/38/07	Footway Crossover Type 1 - Residential	С	31.05.2012	Note at * added	13.05.2014
S278/38/08	Footway Crossover Type 2 - Industrial	С	31.05.2012	Note at * added	13.05.2014
S278/38/09	Service Margins	В	31.05.2012	EF edging omitted for verges abutting walls	09.09.2013
S278/38/10	Preferred Arrangement of Services with Public Highway	Α	31.05.2012	Notes amended	28.02.2013
S278/38/11	Drainage - Gully A Pre-cast Concrete	D	31.05.2012	General Update	15.03.2019
S278/38/12	Drainage - Pre-cast Concrete Ring Soakaway	E	31.05.2012	General Update	15.03.2019
S278/38/13	Drainage - Type B Catchpit	E	31.05.2012	Minimum pipe diameters added	15.03.2019
5278/38/14	Drainage - Type B Vortex Flow Control	С	31.05.2012	General Update	15.03.2019
S278/38/15	Street Furniture - Rumble Strips	С	31.05.2012	Block paving to be butt jointed	25.04.2017
S278/38/16	Street Furniture - Ramp Feature	E	31.05.2012	Ramp Gradients amended	19.01.2024
S278/38/17	Street Furniture - Bollards	В	31.05.2012	Notes amended	13.05.2014
S278/38/18	Street Furniture - Tactile Crossings	Α	31.05.2012	Notes amended	28.02.2013
S278/38/19	Street Furniture - Refuge Islands	D	31.05.2012	'TVL requirements' changed to 'WSCC standards'. Bollard offset and tactile dims added	14.12.2015
S278/38/20	Carriageway - Tie-in Options	В	31.05.2012	IAN 154/12 extract amended	28.02.2013
S278/38/21	Carriageway - Flexible Specification	F	31.05.2012	HRA spec added, CBR notes amended, road type thresholds added, preference for herringbone block paviour pattern.	12.04.2019
1605.2016	Chute Gully	-	28.02.2013	Inital Issue	28.02.2013
S278/38/23	Headwall Detail - Concrete Bagwork up to 600 diam	Α	25.09.2013	Exposed pipes to be UV stable	25.04.2017
S278/38/24	Headwall Detail - Engineering Brickwork up to 600 diam	Α	25.09.2013	Exposed pipes to be UV stable	25.04.2017
S278/38/25	Highway Ditch detail	Α	14.12.2015	Exposed pipes to be UV stable	25.04.2017
S278/38/26	Highway Swale Detail	Α	14.12.2015	Exposed pipes to be UV stable	25.04.2017
S278/38/27	Highway Swale - Check dam detail	-	14.12.2015	Initial Issue	14.12.2015
S278/38/28	Trench Soakaway	Α	07.11.2017	General Update	15.03.2019
S278/38/29	Filter Drain Collector	Α	07.11.2017	General Update	15.03.2019
S278/38/30	Permeable Carriageway Sht 1	Α	07.11.2017	General Update	15.03.2019
S278/38/31	Permeable Carriageway Sht 2	А	07.11.2017	General Update	15.03.2019
S278/38/32	Simple Headwall	А	07.11.2017	General Update	15.03.2019
S278/38/33	Pipe Bedding	Α	07.11.2017	General Update	15.03.2019
5278/38/34	Cellular Storage Sht 1	Α	07.11.2017	General Update	15.03.2019
S278/38/35	Cellular Storage Sht 2	Α	07.11.2017	General Update	15.03.2019
S278/38/36	Pipe Junctions - Lateral Connections	Α	07.11.2017	General Update	15.03.2019

WSCC would be pleased to make full CAD versions of these drawings available to other highway authorities who may wish to use them. - Please contact: planning.services@westsussex.gov.uk

l H G	All changes dates Jan 2024 All changes dates April 2019 All changes dates March 2019	DJL MJA MJA		DJL MJA MJA	19.01.24 12.04.19 15.03.19
Rev	Revision details	Ch	kd	Appd	Date
Drawn: MJA			Fo	For comment	
Chkd:			For tender		r
Appd:			For construction		ruction
Date: 28.02.2013			As	constr	ucted

File ref: IWP Ref: West Sussex County Council Infrastructure Group County Hall,

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Project Name

Section 278/38 Highway Agreement Standard Details

Drawing Title

Drawing Index Sheet



Original Drawing Size : A3

Scale: N/A Dimensions:

Drawing No. S278/38/00



	CDM HAZA	KD A	SSESSI	VIENI
No:	Title	Rev:	Comment Date:	Potential Hazards:
S278/38/01	Alternative Methods of Laying Kerbs	С	15.11.2017	Strain injury due to repetitive lifting. Kerbs to be lifted mechanically.
S278/38/02	Approved Kerb Type Selection Sheet 1	В	15.11.2017	Strain injury due to repetitive lifting. Kerbs to be lifted mechanically.
S278/38/03	Approved Kerb Type Selection Sheet 2	Α	15.11.2017	Strain injury due to repetitive lifting. Kerbs to be lifted mechanically.
S278/38/04	Footway/Cycleway Type 1 & 2	В	15.11.2017	-
S278/38/05	Footway/Cycleway Type 3 & 4	С	15.11.2017	-
S278/38/06	Public Footpath (Rural) Type 5	Α	15.11.2017	Deterioration of surface uniformity over time. Surface to be monitored and repaired as required.
S278/38/07	Footway Crossover Type 1 - Residential	С	15.11.2017	-
S278/38/08	Footway Crossover Type 2 - Industrial	С	15.11.2017	-
S278/38/09	Service Margins	В	15.11.2017	-
S278/38/10	Preferred Arrangement of Services with Public Highway	Α	15.11.2017	-
S278/38/11	Drainage - Gully A Pre-cast Concrete	D	15.03.2019	-
S278/38/12	Drainage - Pre-cast Concrete Ring Soakaway	E	15.03.2019	Unknown depth of chamber when full. Consider installin signage and omitting step rungs.
S278/38/13	Drainage - Type B Catchpit	E	15.03.2019	Unknown depth of sump when full. Consider installing signage and omitting step rungs.
S278/38/14	Drainage - Type B Vortex Flow Control	С	15.03.2019	Unknown depth of chamber if full due to blockage. Consider installing signage.
S278/38/15	Street Furniture - Rumble Strips	С	15.11.2017	-
S278/38/16	Street Furniture - Ramp Feature	D	15.11.2017	-
S278/38/17	Street Furniture - Bollards	В	15.11.2017	-
S278/38/18	Street Furniture - Tactile Crossings	Α	15.11.2017	-
S278/38/19	Street Furniture - Refuge Islands	D	15.11.2017	-
S278/38/20	Carriageway - Tie-in Options	В	15.11.2017	-
S278/38/21	Carriageway - Flexible Specification	E	15.11.2017	Strain injury due to repetitive lifting of blocks. Consider laying Blocks mechanically.
S278/38/22	Chute Gully	-	15.11.2017	-
S278/38/23	Headwall Detail - Concrete Bagwork up to 600 diam	А	15.11.2017	Falling from height. Consider installation of edge protection.
S278/38/24	Headwall Detail - Engineering Brickwork up to 600 diam	A	15.11.2017	Falling from height. Consider installation of edge protection.
S278/38/25	Highway Ditch detail	Α	15.11.2017	Falling from height. Consider installation of edge protection.
S278/38/26	Highway Swale Detail	A	15.11.2017	Falling from height. Consider installation of edge protection.
S278/38/27	Highway Swale - Check dam detail	-	15.11.2017	-
S278/38/28	Trench Soakaway	А	15.03.2019	-
S278/38/29	Filter Drain Collector	А	15.03.2019	Silt removal maintenance to be undertaken using vacuu apparatus from ground level.
S278/38/30	Permeable Carriageway (Sheet 1)	А	15.03.2019	-
S278/38/31	Permeable Carriageway (Sheet 2)	А	15.03.2019	-
S278/38/32	Headwall Detail - Pipes 150Ø - 450Ø	Α	15.03.2019	Falling from height. Consider installation of edge protection.

CDM Regulations 2015:

- In preparing the following drawings West Sussex County Council would fall under the scope
 of a Designer as defined by the CDM regulation 2015. However, as these drawings are not
 project specific it is not possible for West Sussex County Council to list all hazards that may
 occur because of the implementation of the details.
- 2. The Project team must determine any hazards associated with their project due to the implementation of these details.
- The comments against each detail may or may not apply to a project but are given to assist
 the project team and to meet West Sussex County Councils obligations under the
 Regulations. The comments are made on the basis that work will be undertaken by a
 competent company/person.
- 4. West Sussex County Council must be informed of the Dutyholders and be provided with the project teams hazard assessment.
- The client and project team must ensure that all drawings, specifications and the West Sussex County Council Section 278/38 Highway Agreement Standard Details are supplied to the contractor responsible for implementing the Highway Works.

	CDM HAZARD ASSESSMENT						
No:	Title	Rev:	Comment Date:	Potential Hazards:			
S278/38/33	Pipe Bedding	Α	15.03.2019	-			
S278/38/34	Cellular Storage (sheet 1)	А	15.03.2019	Strain injury due to repetitive lifting. Kerbs to be lifted mechanically.			
S278/38/35	Cellular Storage (sheet 2)	Α	15.03.2019	-			
S278/38/36	Lateral Connections	Α	15.03.2019	-			

A -	General update Initial Issue	MJA -		MJA -	15.03.19	
Rev	Revision details	Ch	kd	Appd	Date	
Drawn: MJA			Fo	For comment		
Chkd:			For tender		r	
Appd:			For construction		ruction	
Date: 07.11.2017			As	constr	ucted	

File ref: IWP Ref: West Sussex County Council Infrastructure Group County Hall,

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Project Name

Section 278/38 Highway Agreement Standard Details

Drawing Title
CDM

Original Drawing Size :

Scale : N/A Dimensions :

Drawing No.


А3

S278/38/CDM


Α



0 100

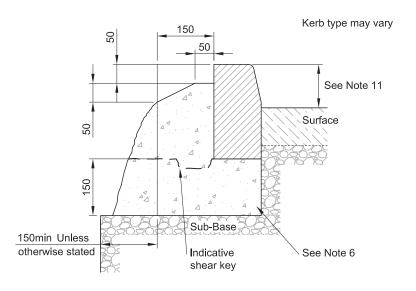

GREEN BED METHOD
(1:10)

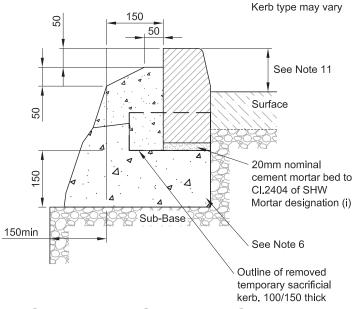

FORMED BASE METHOD

NOTE

- 1. Do not scale from this drawing.
- Kerbs to be butt jointed. Where kerb alignments incur 'minor open joint tapers' in excess of 5mm between formed surfaces mortar jointing shall be used as directed by Highway Inspector.
- 3. All full length PCC kerbs are to be mechanically handled.
- 4. All precast concrete Kerbs & Edgings shall be to BS EN 1340 & laid to BS 7533-6
- 5. All setts of natural stone shall be to BS EN 1342 & laid to BS 7533-7.
- All Kerbs & Edgings bed & backing to be Concrete Class ST1 (C6/8), well compacted. Unless otherwise stated this shall be a minimum bed thickness of 150mm.
- 7. The minimum length of any cut kerb shall be 450mm (Half kerb).
- The correct radius kerbs shall be used for all radii of 12m or less. For radii between 12m and 20m 600mm long straight units shall be used. Radius kerbs shall be used to form corners of laybys.
- The correct transition kerbs shall be used for all drop kerb and upstand variation locations.
- 10. The correct quadrant kerbs shall be used to form corners of square areas and refuge islands. Cut quadrants are permissible.
- Full height kerb upstand shall be 125mm unless otherwise agreed by WSCC under a formal request.
- 12. Drop kerb upstand shall be 0-6mm for pedestrian crossings, 25mm for vehicular crossings.
- 13. Carriageway reinstatements shall be made using material that matches the adjacent carriageway surface.

C B A	Note 13 100mm Temp Kerb shown Formed Base Temp Kerb added	DJ DJ DJ	L	HM GM GM	25/04/17 09/09/13 30/11/12
Rev	Revision details	Ch	kd	Appd	Date
Drawn: MJA			For comment		
Chkd: DJL			For tender		r
Appd:	APH		Fo	r consti	ruction
Date:			As	constr	ucted

File ref: IWP Ref: West Sussex County Council Infrastructure Group

County Hall, West Street Chichester West Sussex PO19 1RH (01243) 642105



Project Name

Section 278/38 Highway Agreement Standard Details

Drawing Title

Alternative Methods of Laying Kerbs



Original Drawing Size : A3


Scale: As Shown Dimensions:

Drawing No.


S278/38/01

Rev C



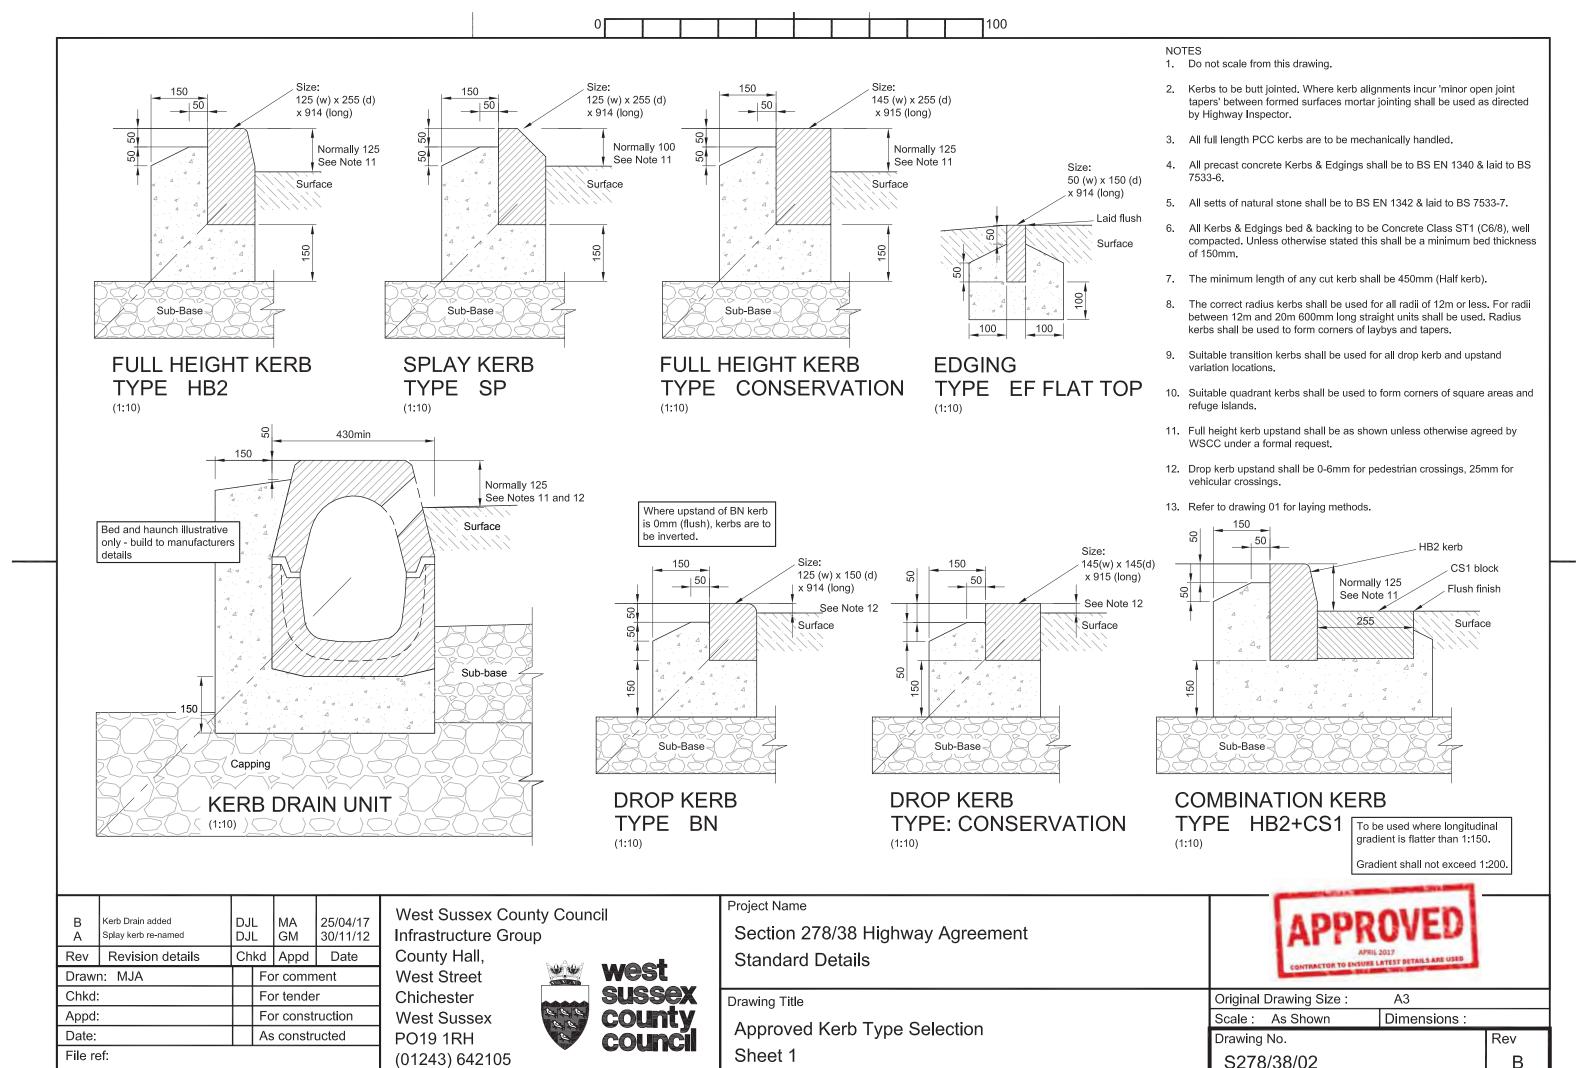


IWP Ref:

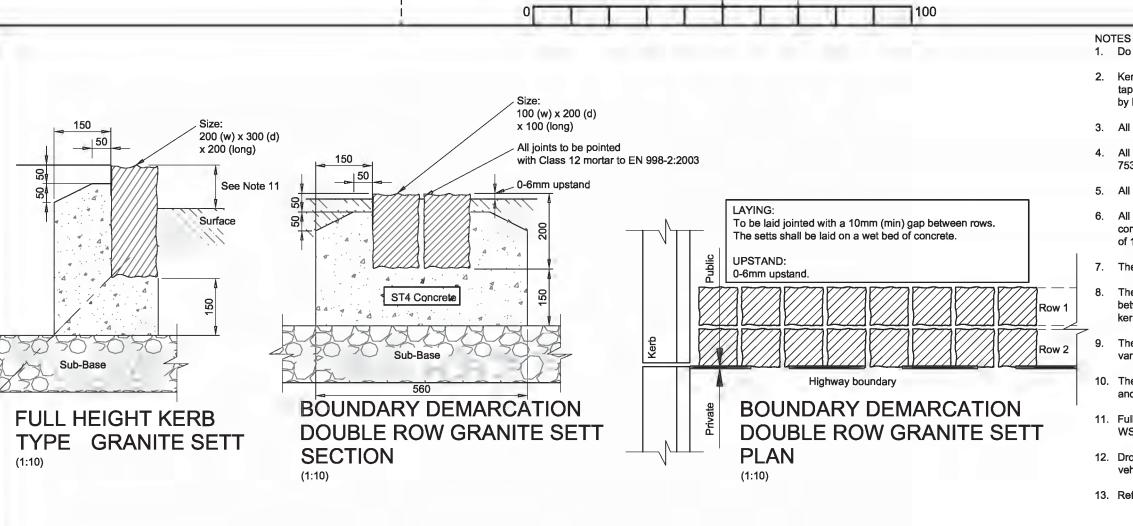

1. Do not scale from this drawing

- 2. Kerbs to be butt jointed. Where kerb alignments incur 'minor open joint tapers' between formed surfaces mortar jointing shall be used as directed by Highway Inspector.
- 3. All full length PCC kerbs are to be mechanically handled
- All precast concrete Kerbs & Edgings shall be to BS EN 1340 & laid to BS
- 5. All setts of natural stone shall be to BS EN 1342 & laid to BS 7533-7.
- 6. All Kerbs & Edgings bed & backing to be Concrete Class ST1 (C6/8), well compacted. Unless otherwise stated this shall be a minimum bed thickness of 150mm. Carriageway demarcation CS1/Granite setts to be ST4 (C16/20)
- 7. The minimum length of any cut kerb shall be 450mm (Half kerb).
- The correct radius kerbs shall be used for all radii of 12m or less. For radii between 12m and 20m 600mm long straight units shall be used. Radius kerbs shall be used to form corners of laybys and tapers.
- The correct transition kerbs shall be used for all drop kerb and upstand variation locations.
- 10. The correct quadrant kerbs shall be used to form corners of square areas and refuge islands.
- 11. Full height kerb upstand shall be 125mm unless otherwise agreed by WSCC under a formal request.
- 12. Drop kerb upstand shall be 0-6mm for pedestrian crossings, 25mm for vehicular crossings.
- 13. Refer to drawing 01 for laying methods.

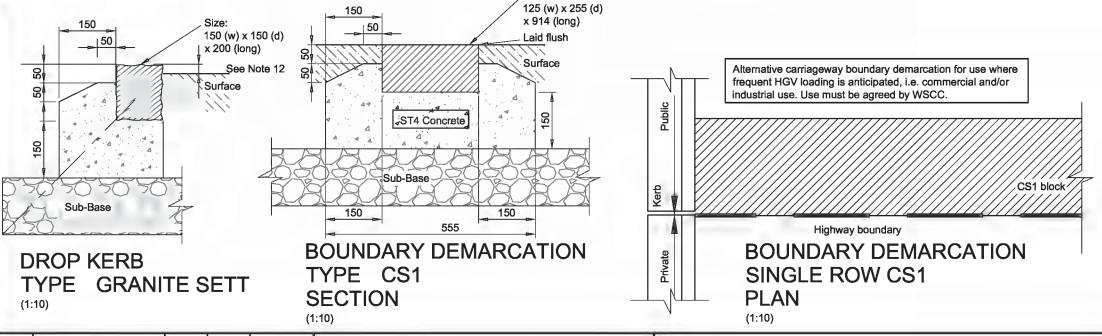

Corrected ref to CS1 GM 30/11/12 Chkd Appd Date Rev Revision details Drawn: MJA For comment Chkd: For tender Appd: For construction Date: As constructed

File ref: **IWP Ref:**

West Sussex County Council Infrastructure Group

County Hall, West Street Chichester **West Sussex** PO19 1RH (01243) 642105



Project Name

Section 278/30 Highway Agreement **Standard Details**


Drawing Title

Approved Kerb Type Selection Sheet 2




Original Drawing Size: A3 Scale: As Shown Dimensions: Drawing No. Rev S278/38/03 Α



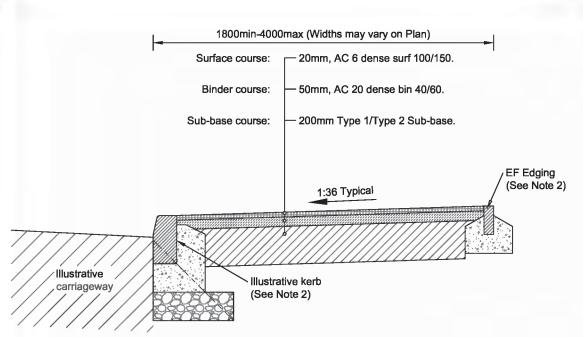

TYPE 1
FLEXIBLE FOOTWAY CONSTRUCTION
(Adjacent Carriageway)
(Scale 1:20)

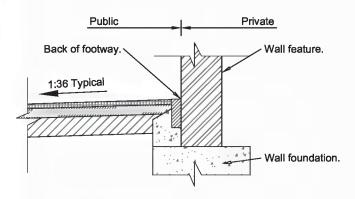

FLEXIBLE CONSTRUCTION ADJACENT WALL

(Scale 1:20)

IWP Ref:


PROPOSED WALL SCENARIO
The back of footway shall be formed with an EF
Edging.

HISTORIC WALL SCENARIO

Where works are proposed directly adjacent an existing wall feature the Highway Inspector shall review the edging requirement on a case by case basis.




Tramline Paviour.
Use to denote cycleway side of segregated footway / cycleways. Arrow denotes direction of approach.

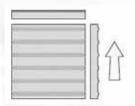


Corduroy Warning Paviour.
Use at pedestrian entry onto cycle paths or shared surfaces, and at top and bottom of steps. Arrow denotes direction of approach.

TACTILE PAVING (Scale 1:20) - See note 10

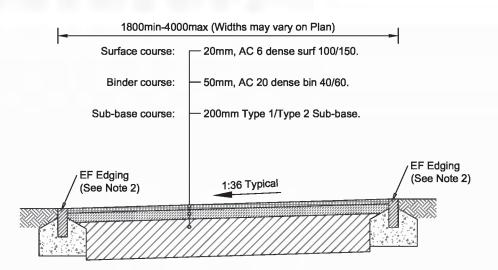

TYPE 2 FLEXIBLE FOOTPATH CONSTRUCTION (Separate from Carriageway)

(Scale 1:20)

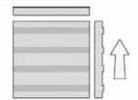

Ladder Paviour.
Use to denote footway side of segregated footway / cycleways. Arrow denotes direction of approach.



Blister Paviour:
Buff at uncontrolled
pedestrian crossing points.
Red at Zebra and
Signalised crossing points.
See Drawing 18



Guidance Path paviour. Used extremely rarely. Check with WSCC Inspector before installing.

Small element tactile paviours to be used where vehicular overrun is likely to break slabs

NOTES

- 1. Do not scale from this drawing.
- 2. Refer to drawings 02 & 03 for Approved Kerb Type Selection.
- 3. Refer to drawing 01 for laying methods.
- Prior to the commencement of laying the formation shall be treated with an approved residual weedkiller.
- The Highway Inspector may request inclusion of a non-woven separation membrane to mitigate weed/root intrusion.
- The Highway Inspector may increase the Sub-base depth or include a geotextile or geogrid on formation where site ground conditions are considered to be sub-standard.
- Where there are footways without vehicle crossovers sub-base may be reduced to 100mm.
- None of the details on this drawing are suitable where 'no-dig' construction is required.
- Where a footpath is proposed between walls, private land or other features then positive drainage will be necessary in order to prevent run off of highway surface water.
- Tactile paving to be specified and installed in accordance with DETR guidance on the Installation of Tactile Paving 1998

	FOOTWAY	CROSSOVER	CROSSOVER
	FOOTWAY	TYPE 1	TYPE 2
		(STANDARD)	(INDUSTRIAL)
		(STANDARD)	(IIVDOSTRIAL
SUB-BASE			
Type 1 / Type 2 (Clause 803)	200 (See Note 7)	200	270
BASE			
32mm Dense Asphalt Concrete	-	-	100
Base 40/60 PEN			
BINDER COURSE			
20mm Dense Asphalt Concrete	50	50	50
Binder 40/60 PEN			
(Not required with block paviors)			
SURFACE COURSE			
Heavy Traffic Option:	25	25	25
HRA 30/10 F Surf 40/60			
HRA 45/6 Surf 160/220			
6mm Dense Graded Asphalt Concrete	20	20	_
Surface Course 100/150			
10mm Close Graded Asphalt Concrete	-	_	30
Surface Course 100/150			
Blocks on 30mm sand Bed	60	60	60

B	Tactile Paving added	DJ		GM MJA	09.09.13 28.02.13
		DLS			
Rev	Revision details	Ch	Ka	Appd	Date
Drawn: MJA			For comment		
Chkd	Chkd:		For tender		
Appd:			For construction		ruction
Date:			As	constr	ucted
File re	ef:				

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(01243) 642105



Project Name

Section 278/38 Highway Agreement Standard Details

Drawing Title


Footway/Cycleway
Type 1 & 2




Scale: As Shown Dimensions:

Drawing No. Rev
S278/38/04 B



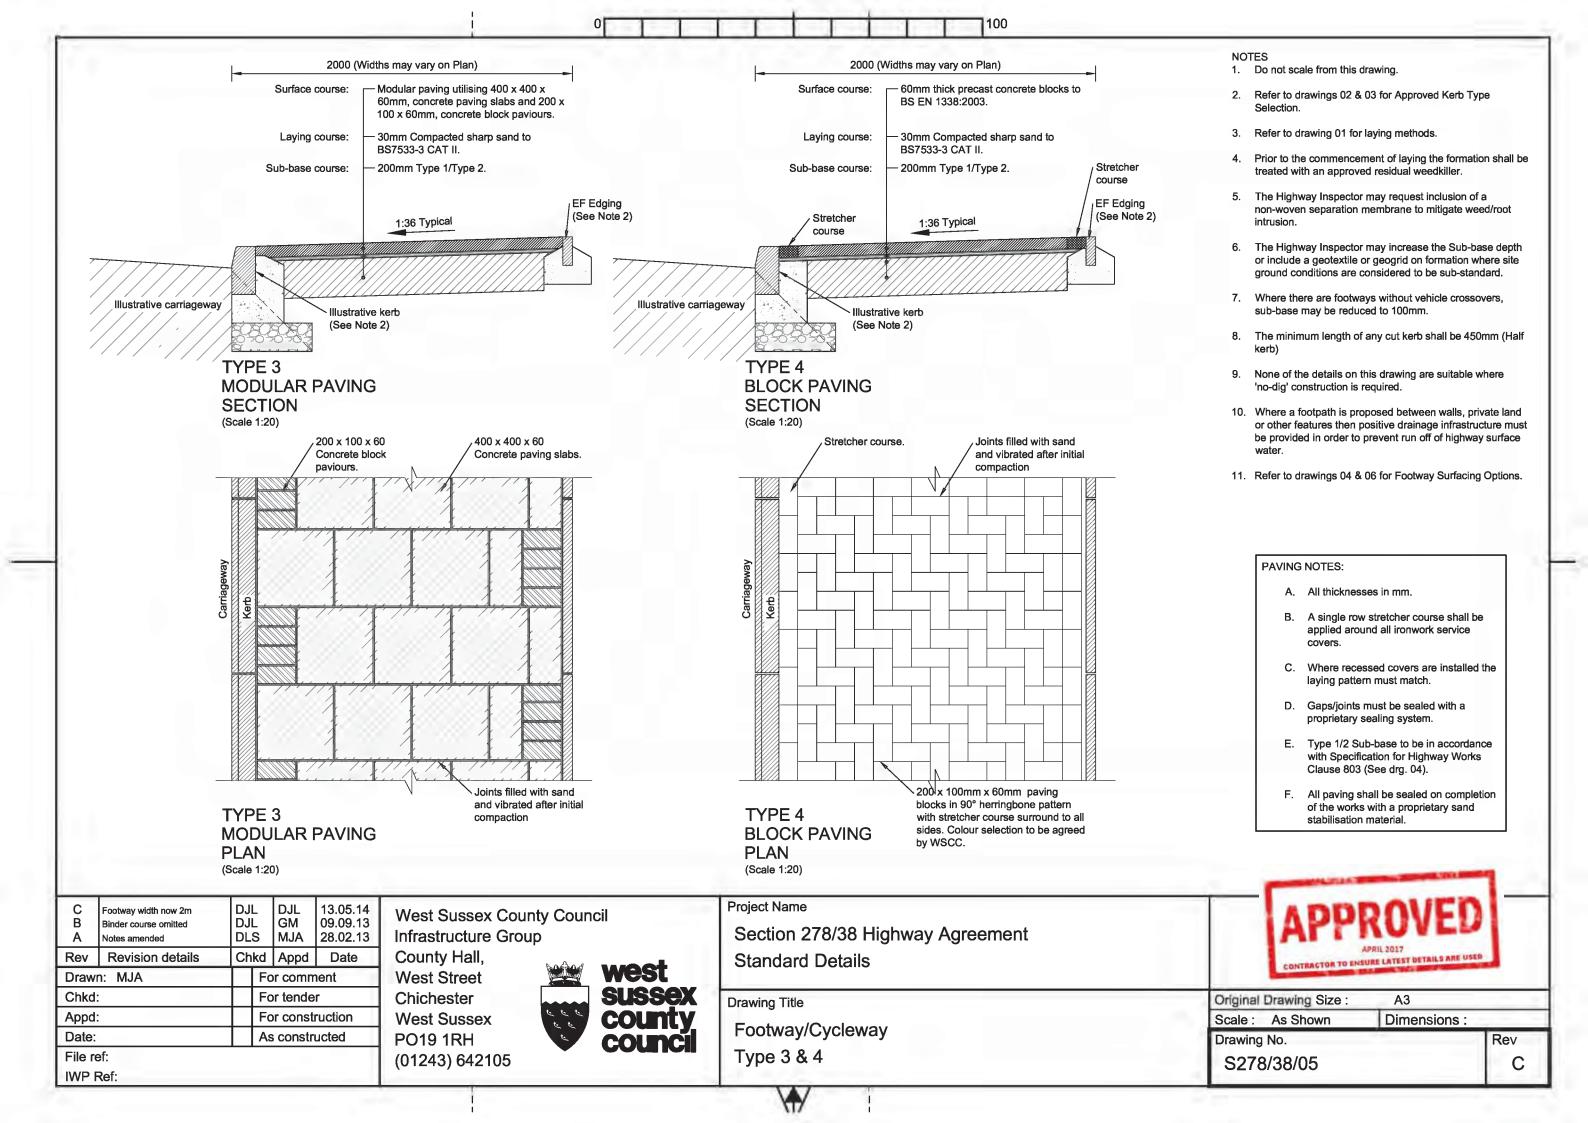

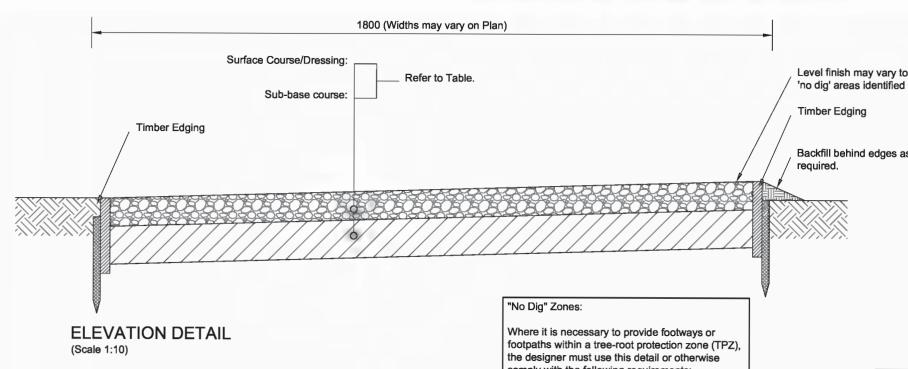

required.

Level finish may vary to suit

Timber Edging

Backfill behind edges as

6. None of the details on this drawing are suitable where 'no-dig' construction is required.

2. All timber shall comply with SHW Clause 304 unless

3. Actual position of footpath/cycleway/bridleway shall be

4. Where footpath routing is in vicinity of trees appropriate

5. The Highway Inspector may increase the Sub-base depth or include a geotextile or geogrid on formation where site ground conditions are considered to be sub-standard.

measures shall be undertaken in accordance with BS5837

determined on site with The Highway Inspector.

and in consultation with the WSCC tree officer.

Do not scale from this drawing.

comply with the following requirements:

- No tree roots are to be severed
- Existing soil must not be compacted
- The construction must allow aeration and run-off

Specialist advice is to be sought in conjunction with approval from WSCC Tree Officer.

Cellweb (or similar approved) may be used, in accordance with manufacturer's specifications.

FOOTPATH - ALTERNATIVE CONST	RUCTION SELECTO	OR				
	RURAL TYPE A	RURAL TYPE B	RURAL TYPE C			
SUB-BASE						
Type 1 (Clause 803) rolled in 2 No. layers	175	175	175			
SURFACE/DRESSING COURSE						
Fittleworth Stone Screened Rubble	75	-	-			
Eco-Mix supplied by Dudmans or equivalent approved by WSCC	-	75	-			
Limestone Dust	-	-	25			

Reinstate verge as

40x150mmx2000mm (min) long treated timber edging with nominal upstand for run off collection. Fixed to stakes by 2 No. 80mm long galvanised nails.

Driven 50x50x450mm long pointed timber stake (See Plan Detail)

PLAN DETAIL (Scale 1:10)

Α	Notes amended	DL	S	MJA	28.02.13
Rev	Revision details	Ch	kd	Appd	Date
Drawn: MJA			For comment		
Chkd:	Chkd:		For tender		
Appd:			Fo	r const	ruction
Date:			As	constr	ucted
File ref:					

IWP Ref:

Infrastructure Group County Hall, **West Street** Chichester West Sussex PO19 1RH (01243) 642105

West Sussex County Council

1000 Centres

Double up stakes where

Verge

timber boards abut.

Project Name

Section 278/38 Highway Agreement Standard Details

(Scale 1:10)

EDGING DETAIL


Drawing Title


Footway/Footpath (Rural) Type 5




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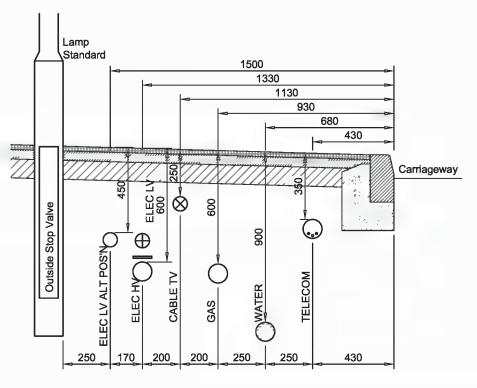
Drawing No. Rev S278/38/06 Α



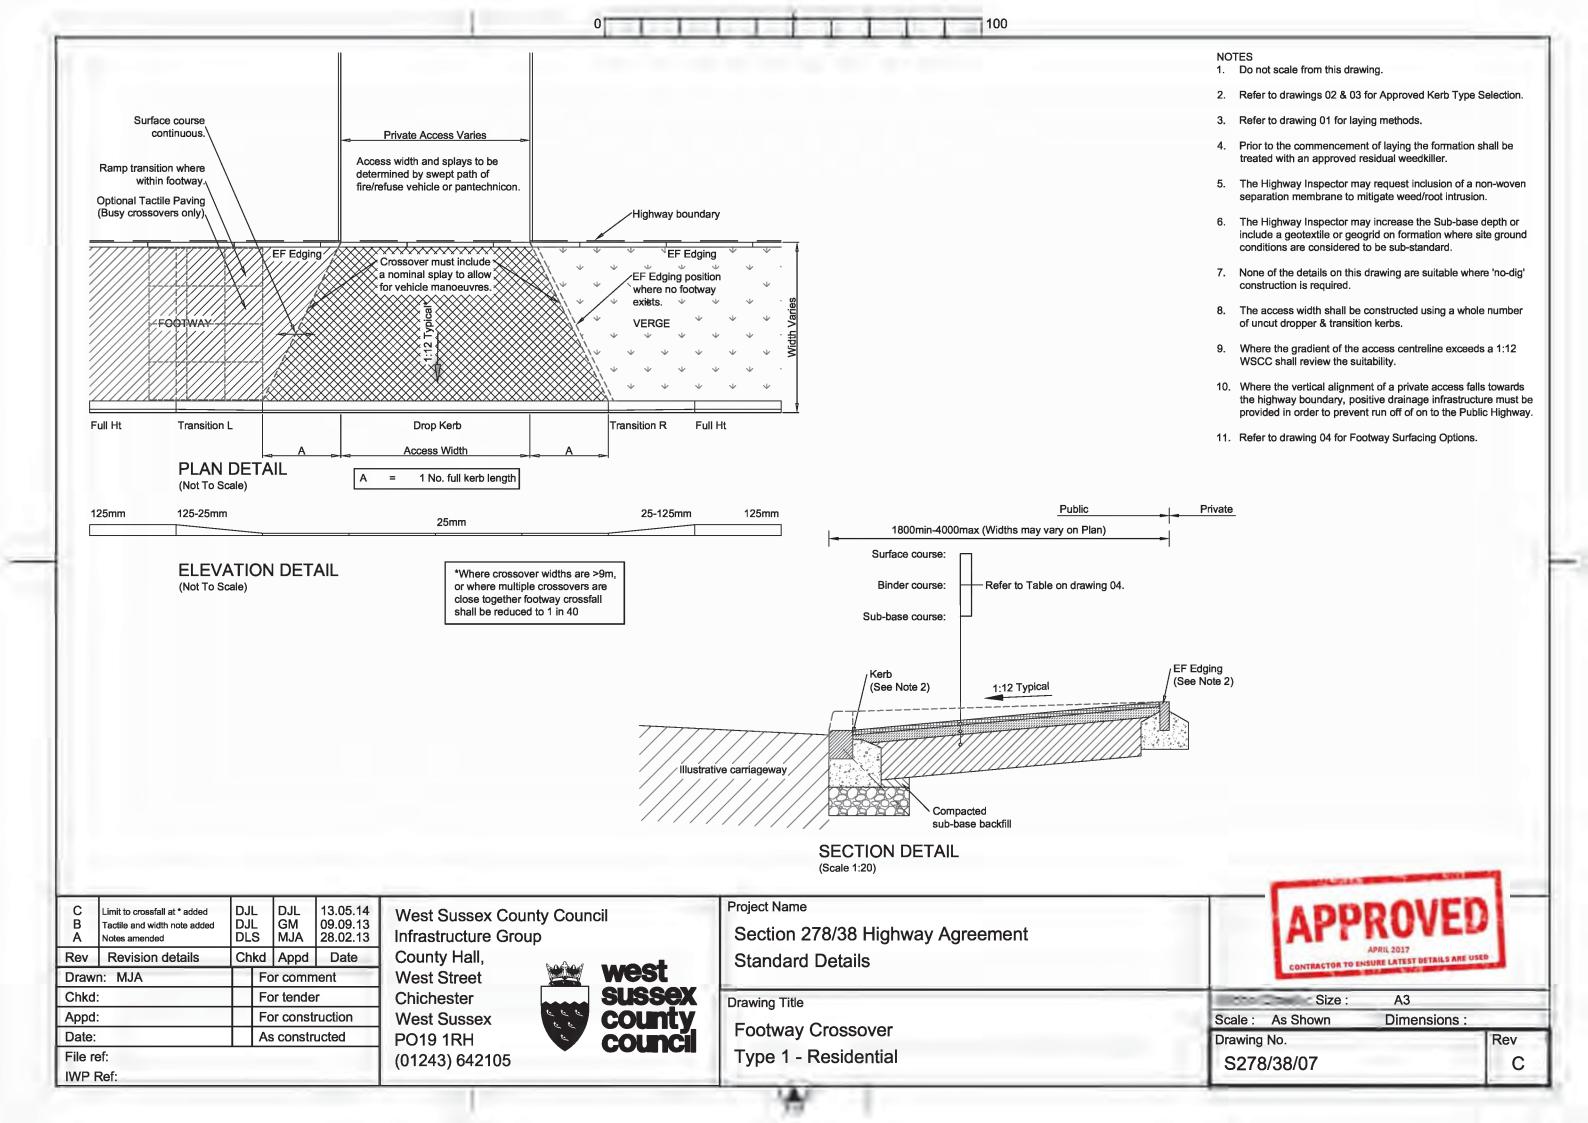


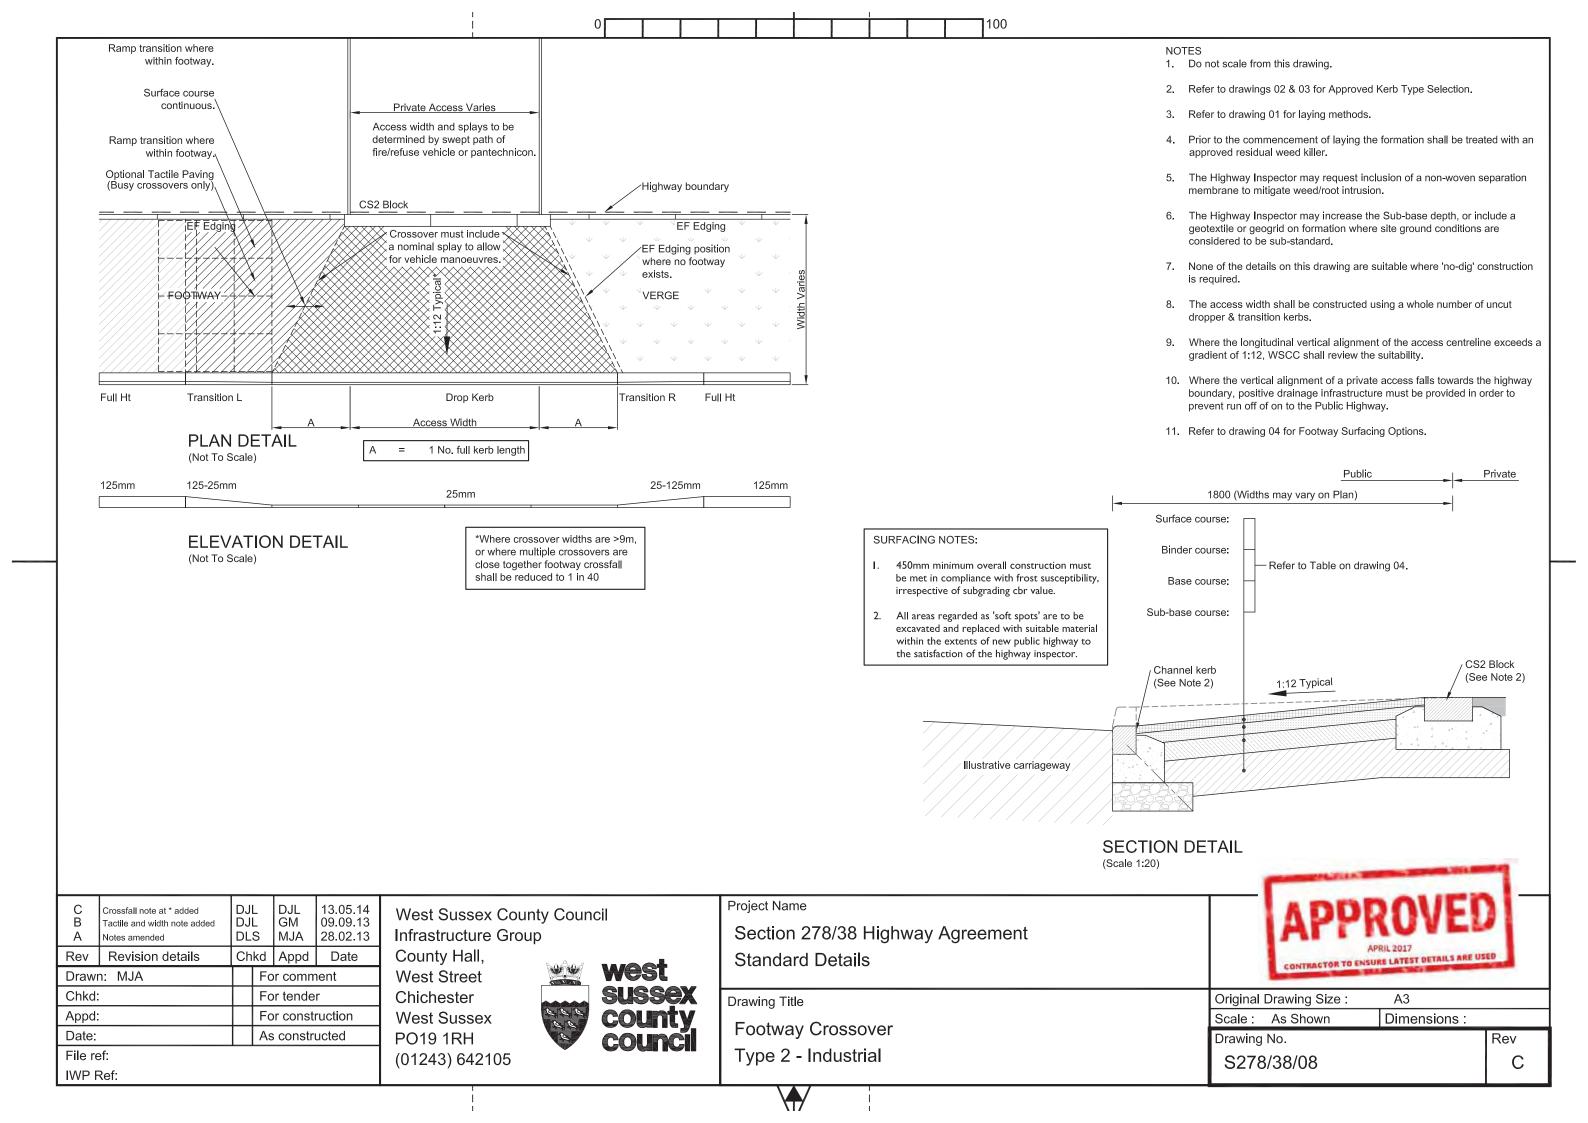

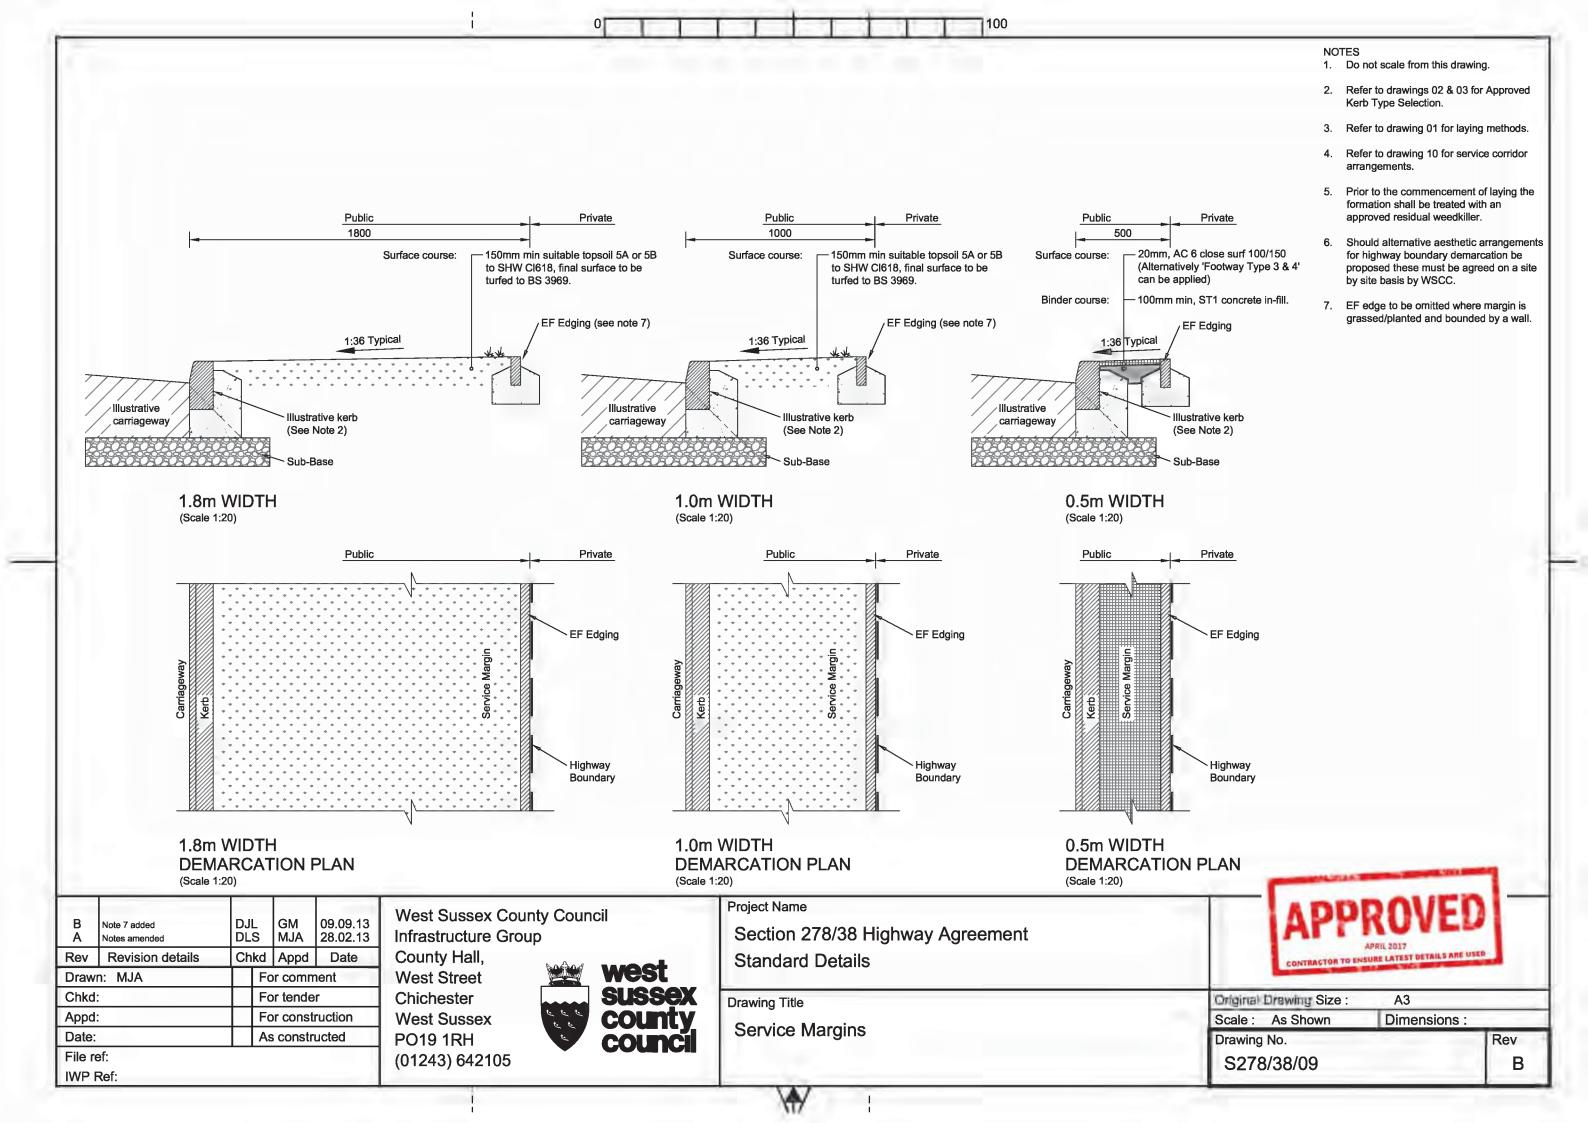- 1. Do not scale from this drawing.
- 2. Refer to drawings 02 & 03 for Approved Kerb Type Selection.
- 3. Refer to drawing 01 for laying methods.
- 4. Refer to drawing 09 for service margin arrangements
- All consultant and/or contractor planning and installation of underground utilities apparatus to be in accordance with NJUG (The National Joint Utilities Group) Guidelines, Volumes 1-5.
- 6. Any variations to the typical depths shown must be qualified by correspondence evidence obtained from the relevant statutory authority.
- 7. Shallow apparatus proposals must be qualified by correspondence evidence obtained from the relevant statutory authority as to the acceptable 'protective measures'. For technical approval a supporting drawing and loading calculations maybe be required.
- 8. With the exception of existing and/or proposed sewers, no services shall be permitted to be routed within or below (includes crossings) a SUDS permeable pavement. Where this is deemed unavoidable WSCC shall review each location on a case by case basis.



RECOMMENDED ARRANGEMENT OF SERVICE MAINS WITHIN FOOTWAY (Scale 1:20)

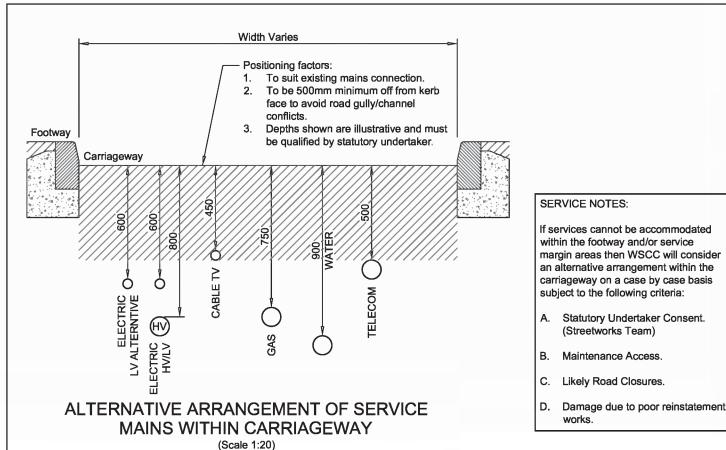

A	Notes amended	DL	s	MJA	28.02.13
Rev	Revision details	Ch	kd	Appd	Date
Draw	Orawn: MJA		For comment		
Chkd:			For tender		
Appd:			Fc	r const	ruction
Date:			As	constr	ucted
File ref:					

IWP Ref:

Chichester **West Sussex** PO19 1RH (01243) 642105

County Hall,

West Street



Project Name

Section 278/38 Highway Agreement Standard Details

Drawing Title

Preferred Arrangement of Services within Public Highway




Charle Drawing Size: A3 Scale: As Shown Dimensions:

Drawing No.

S278/38/10

Rev A



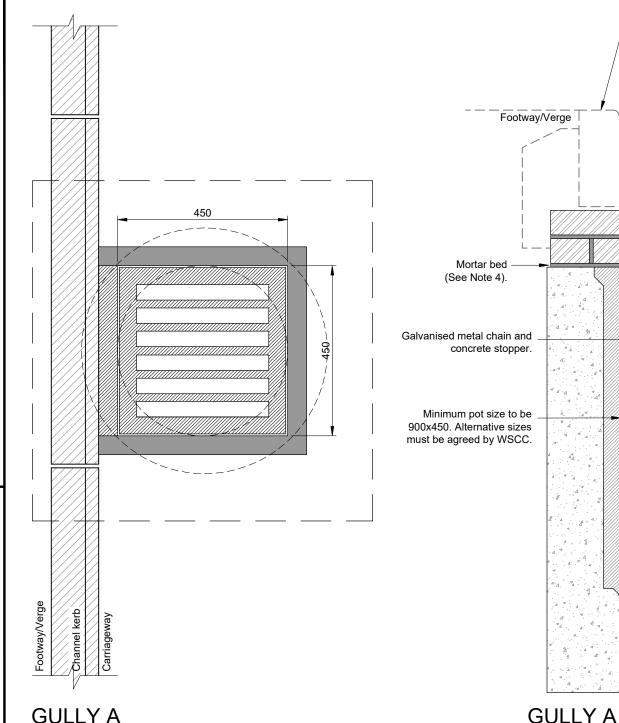

Illustrative channel kerb. Kerb to be adjusted to sit on brickwork. Cover & Frame (See Notes 2 - 4): Cover depths for gullies: 'B' roads and unclassified highways to be 100mm. 'A' roads and higher to be 150mm. Top of gully frame to be 5mm below road surface. Carriageway Outlet Pipe (150Ø) 450 150mm Ø outlet pipe surrounded with 150mm ST4 (C16/20) concrete down to a depth of cover of: 1200mm (Carriageway) 2. 900mm (Footway/Verge) 12mm thk. compressible filler board, or pre-formed joint filler for full thickness of concrete bed and surround. 150mm Insitu concrete bed & surround min grade ST4 (C16/20) to gully pot.

GULLY A
TYPE: PRECAST CONCRETE
PLAN

(1:10)

D MJA MJA 15.03.19 General update С 07.11.17 General update В DJL НМ 25.04.17 Plastic gully pots removed Rev Revision details Chkd Appd Date

Rev Revision details Chkd Appd Date

Drawn: MJA For comment

Chkd: For tender

Appd: For construction

Date: As constructed

File ref: IWP Ref:

West Sussex County Council Infrastructure Group

County Hall, West Street Chichester West Sussex PO19 1RH (01243) 642105



SECTION

(1:10)

Project Name

TYPE: PRECAST CONCRETE

Section 278/38 Highway Agreement Standard Details

Drawing Title

Drainage

Gully A - Pre-Cast Concrete

March 2019
CONTRACTOR TO ENSURE LATEST DETAUS ARE USED

Original Drawing Size :

Scale: As Shown Dimensions:

Drawing No.

S278/38/11

NOTES

1. Do not scale from this drawing

BS EN 771-1:2011.

of the highway inspector.

SURFACE WATER PIPES

Permitted Types as follows:

CLAY: (150@min-300@max)

network (pipes & couplings).

to BS 5911-1:2002.

STRUCTURES (*)

WSCC structures team.

UPVC: (150Ømin-900Ømax) (*) All pipes shall be to BS EN 1401-1:1998.

CONCRETE: (300@min-900@max) (*)

3. All ironwork shall carry a BSI kite mark.

2. All gully grating and frames to be 'hinged' heavy duty ductile

& Section 508 of the Specification of Highway Works.

Frames shall be bedded on a gauged Class 1 (3:1)

iron minimum grade D400 in accordance with BS EN124:1994

sand/cement mortar to Cl.2402 of SHW Mortar Designtation (i),

and either 2 or 3 courses of Engineering Brickwork Class 'B' to

Gully spacing is to be determined from the requirements of HA

102/17, Design Manual for Roads and Bridges, however, maximum area to be drained by one gully: 180 m²

Gully pots used for carriageway gullies shall be of precast concrete using Sulphate Resisting Cement (SRC) in accordance with BS 5911, part 230, 2004.
 All gullies to be trapped. Any variations to this i.e.

'non-trapped', 'qully chute' or 'grip' must be qualified and

WSCC shall review each location on an individual basis.

Refer to drawing 33 for pipe bedding selection.

All pipe shall be Vitrified Clayware to BS EN 295-1:1991.

All pipes shall be ribbed 'twin wall' to provide a suitable

All pipes shall be made with Sulphate resistant Cement

ALL jointing and installation shall be undertaken to manufacturers specification.

ALL materials shall be BBA certified.

ALL materials shall comply with the Specification for Highway Works.


Pipes with a diameter of 0.9m or greater are classified

as a structure and will be subject to review by the

Selection of gully grating type shall be to suit the application area i.e carriageway, footway/cycleway and to the satisfaction

Rev D



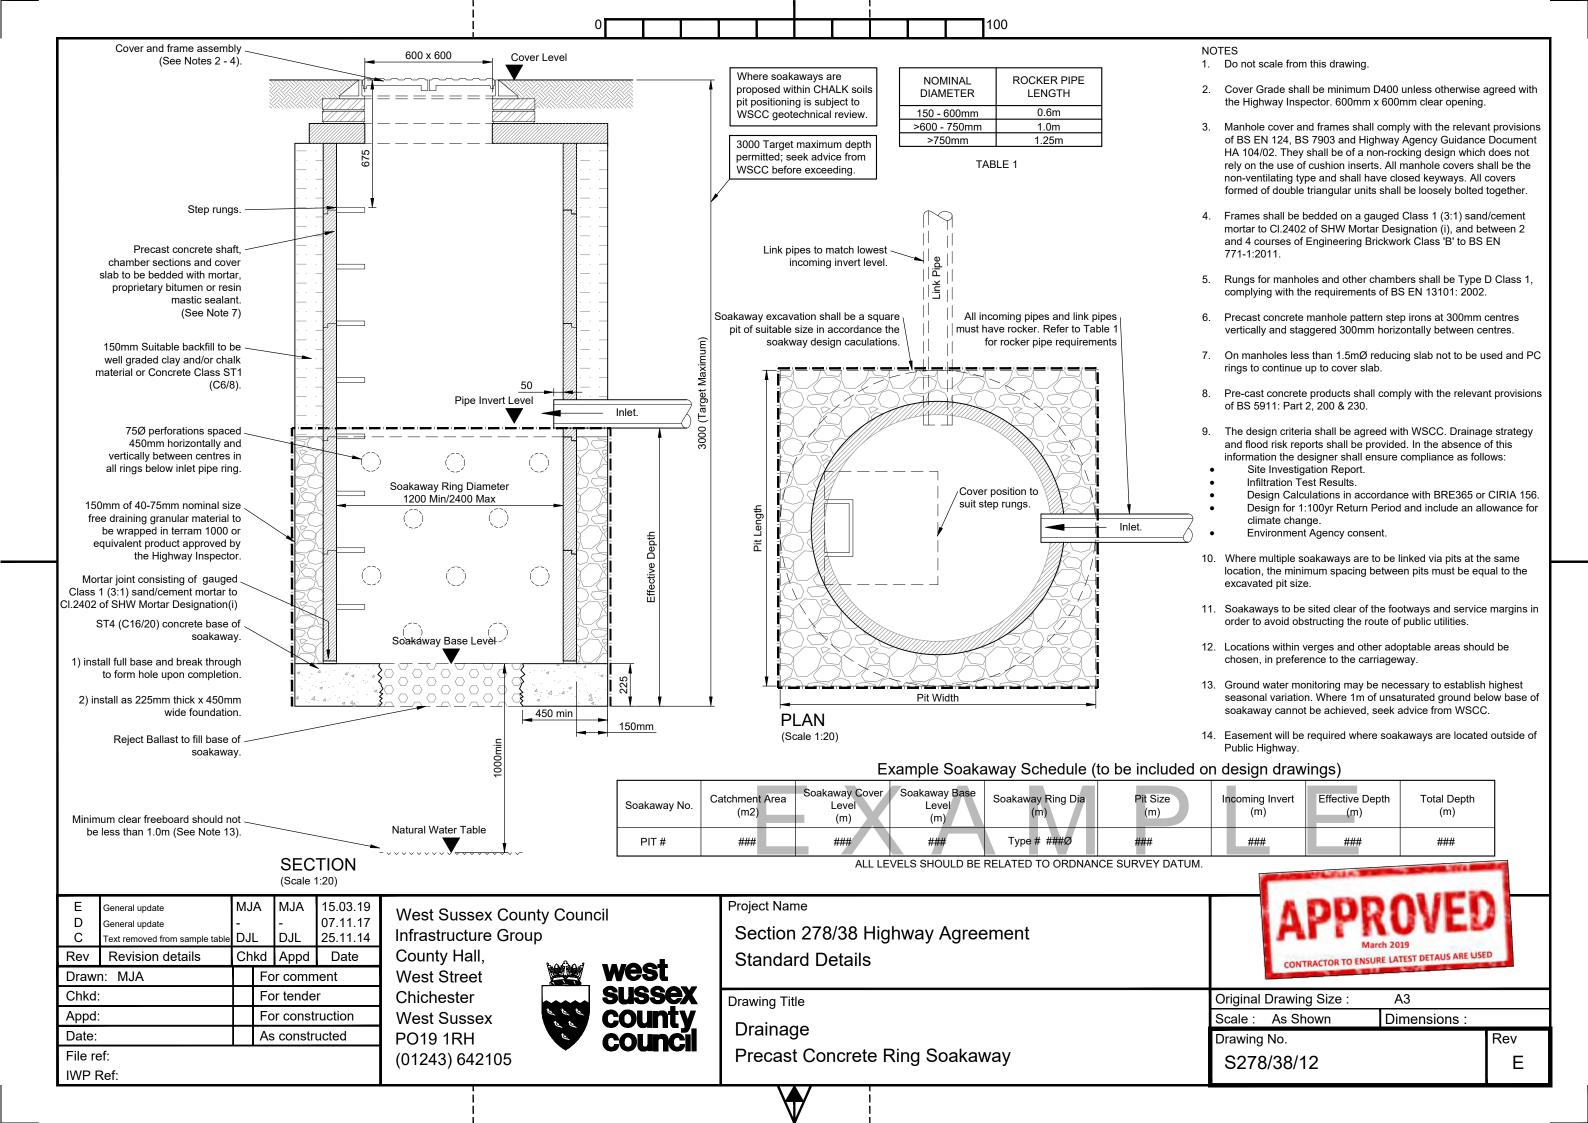

CLEAR OPENING				
Chamber Depth <900mm	600mm x 1200mm			
Chamber Depth >900mm	600mm x 600mm			

TABLE 3.


/50 - 900mi

		_		
DIAMETER OF LARGEST PIPE	INTERNAL DIA. OF MANHOLE		NOMINAL DIAMETER	ROCKER PIPE LENGTH
<375mm	1200mm		150 - 600mm	0.6m
375 - 700mm	1500mm		>600 - 750mm	1.0m
750 - 900mm	1800mm		>750mm	1.25m

TABLE 1.

TABLE 2

Note: Opening to be offset from centre by approximately 200mm for 1200mm diameter shaft with rungs/ladder.

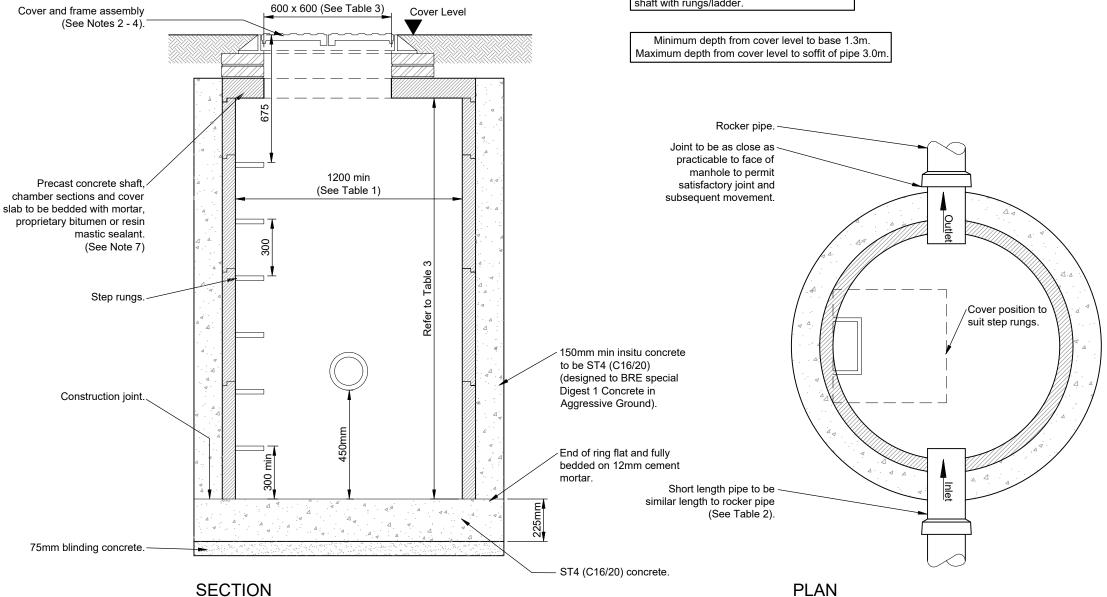

4. Frames shall be bedded on a gauged Class 1 (3:1) sand/cement mortar to Cl.2402 of SHW Mortar Designation (i), and between 2 and 4 courses of Engineering Brickwork Class 'B' to BS EN

design which does not rely on the use of cushion inserts. All manhole covers shall be the non-ventilating type and shall have

closed keyways. All covers formed of double triangular units

 Cover Grade shall be minimum D400 unless otherwise agreed with the Highway Inspector. 600mm x 600mm clear opening

 Manhole cover and frames shall comply with the relevant provisions of BS EN 124, BS 7903 and Highway Agency Guidance Document HA 104/02. They shall be of a non-rocking

1. Do not scale from this drawing.

shall be loosely bolted together.

(Refer to Table 3).

5. Rungs for manholes and other chambers shall be Type D Class 1, complying with the requirements of BS EN 13101: 2002.

Precast concrete manhole pattern step irons at 300mm centres vertically and staggered 300mm horizontally between centres.

 On manholes less than 1.5mØ reducing slab not to be used and PC rings to continue up to cover slab.

8. Pre-cast concrete products shall comply with the relevant provisions of BS 5911: Part 2, 200 & 230.

9. The number of incoming branches and invert levels may vary.

 Cover and frame may be installed as a 'gully top' where appropriate.

11. Min pipe diameter for carrier pipes to be 225mm.

12. Min pipe diameter for gully laterals to be 150mm.

Ε MJA MJA 15.03.19 General update D MJA НМ 07.11.17 General update DJL НМ 25.04.17 С Min pipe diameters added Rev Revision details Chkd Appd Date Drawn: MJA For comment Chkd: For tender Appd: For construction Date: As constructed

(Scale 1:20)

File ref: IWP Ref: West Sussex County Council Infrastructure Group

County Hall, West Street Chichester West Sussex PO19 1RH (01243) 642105



Project Name

Section 278/38 Highway Agreement Standard Details

(Scale 1:20)

Drawing Title

Drainage
Type B Catchpit




Original Drawing Size : A3


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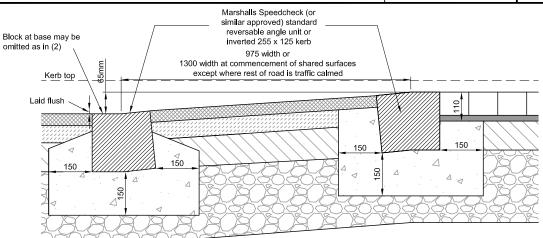
Drawing No. S278/38/13

Rev E






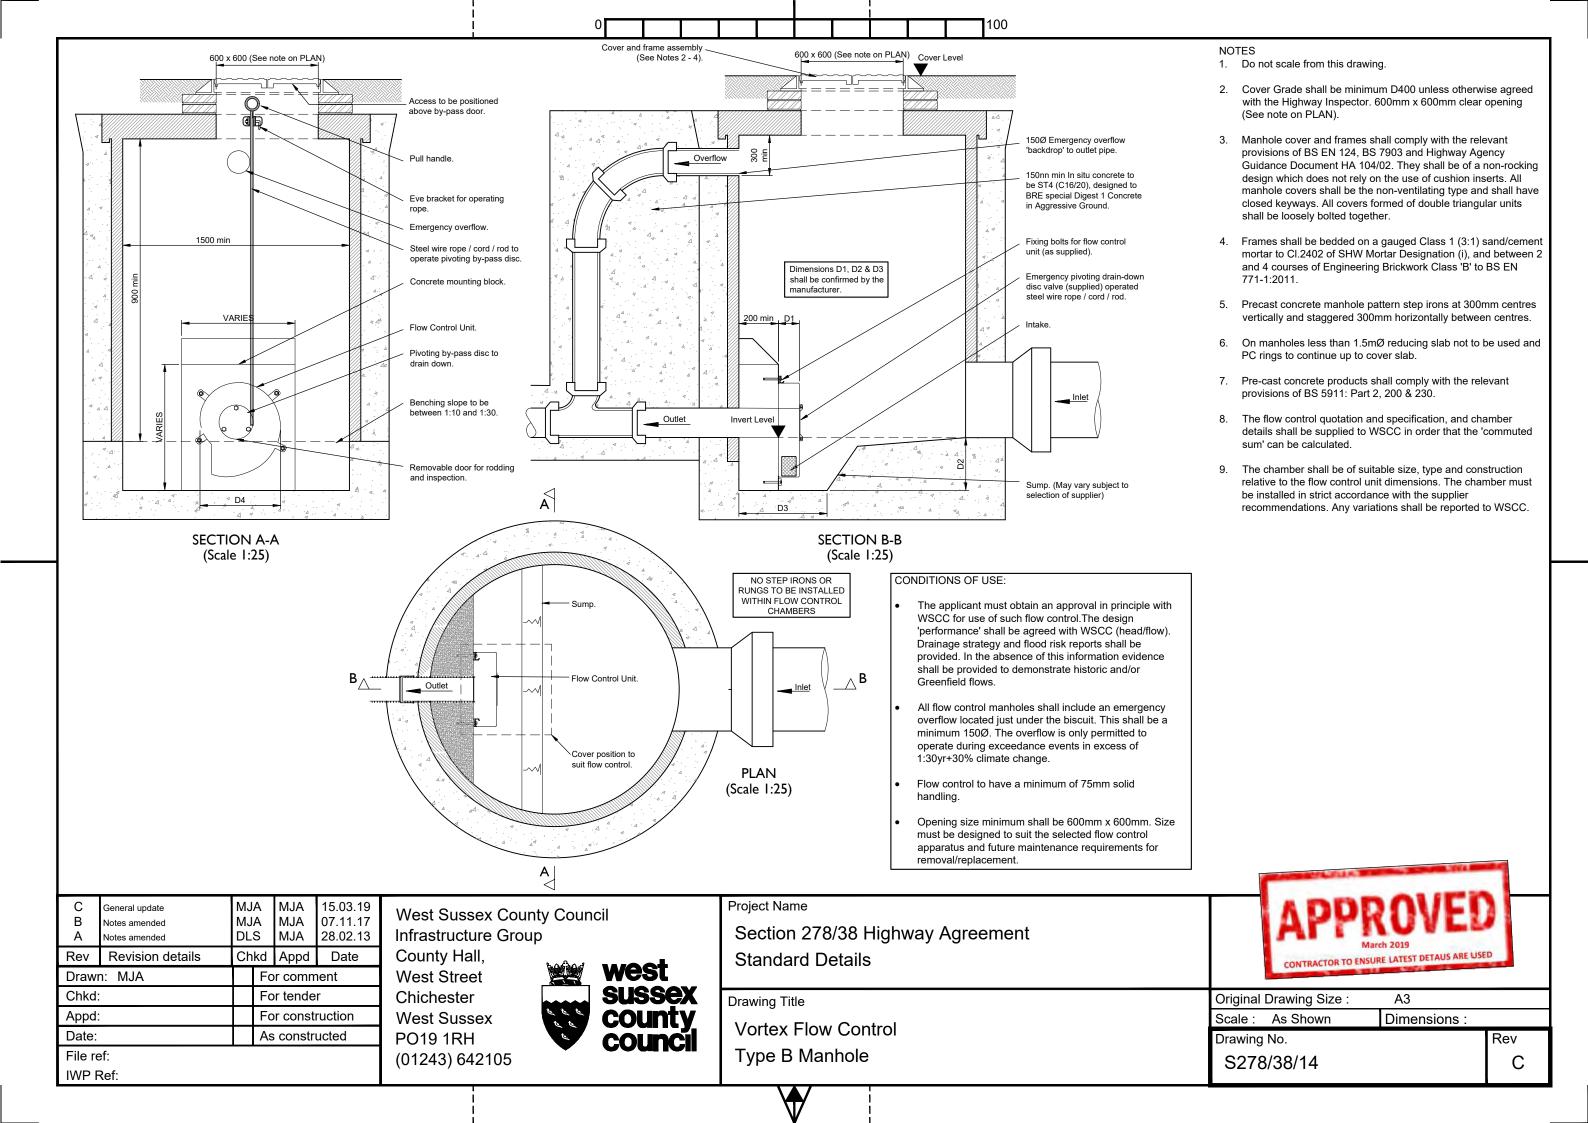


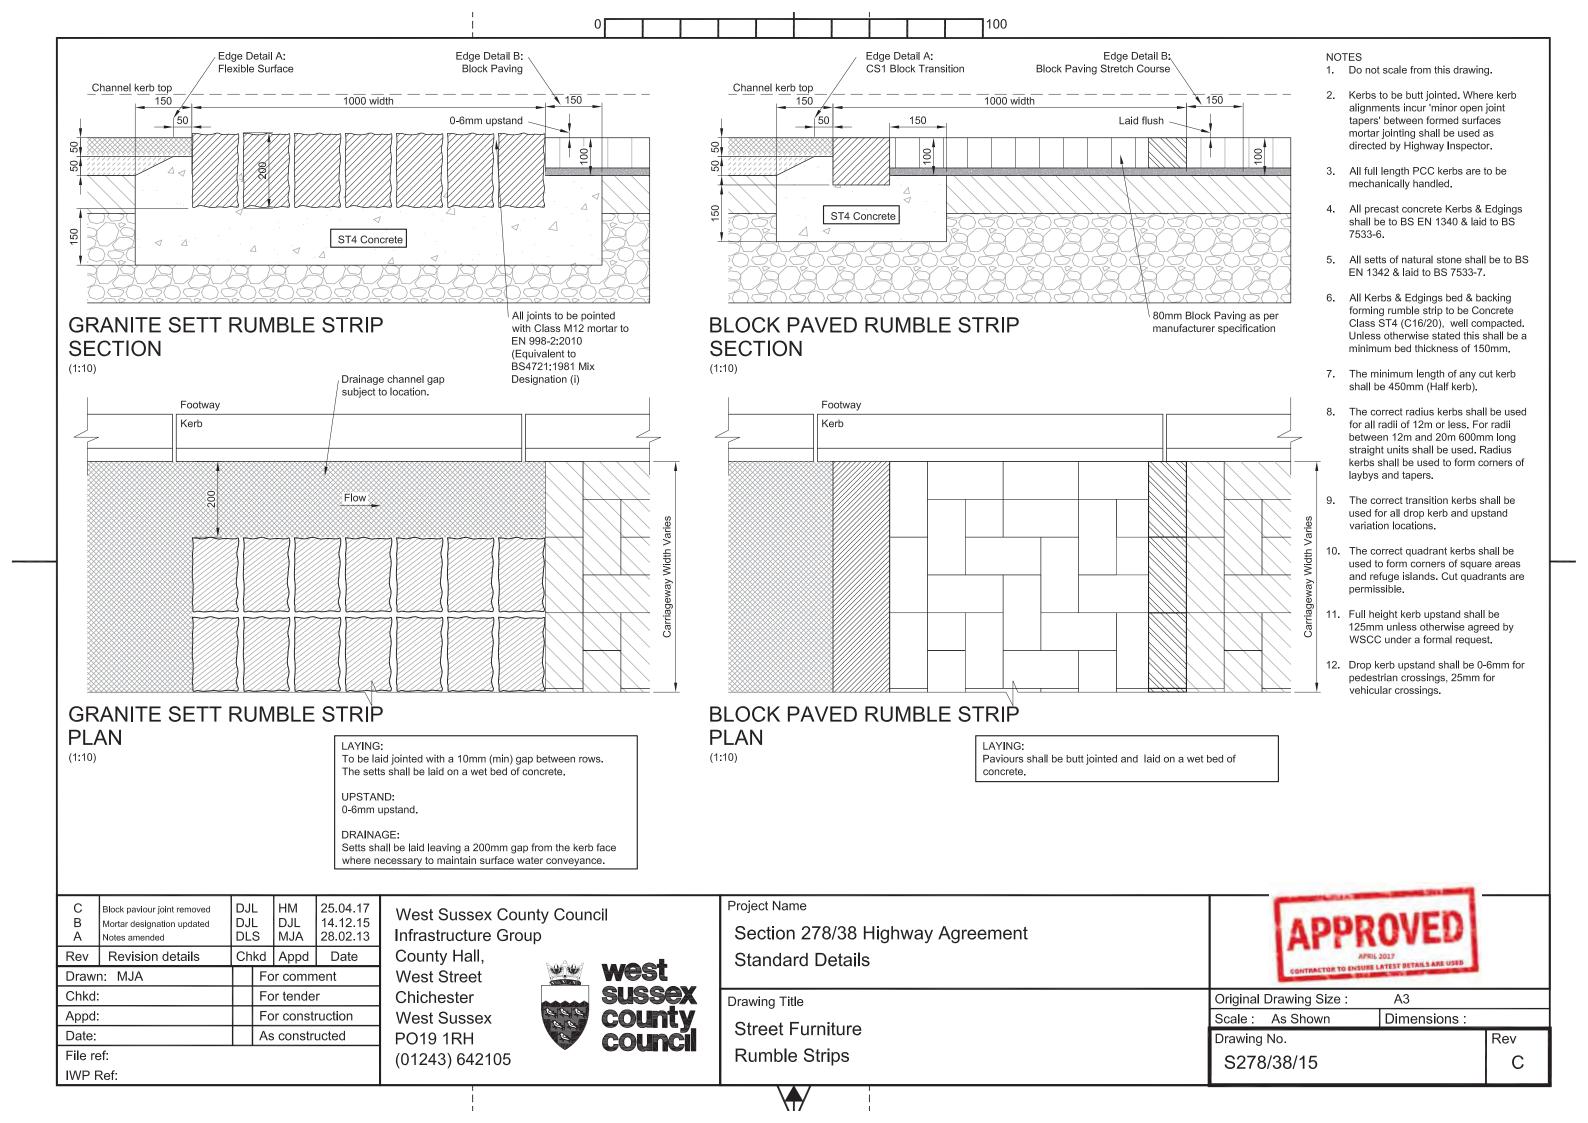

(1) ASPHALT CONCRETE ROAD, BLOCK PAVED RAMP - WITH DIAG 1062 MARKING (NTS)

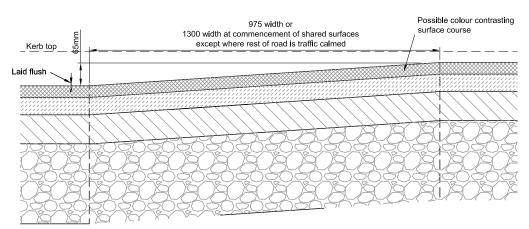

(2) ASPHALT CONCRETE ROAD AND RAMP - WITH DIAG 1062 MARKING (NTS)

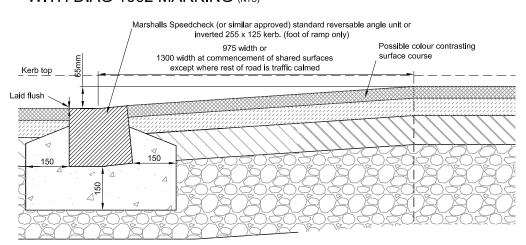

(3) ASPHALT CONCRETE ROAD AND RAMP - DIAGRAM 1062 MARKING OMITTED (20mph ZONES ONLY) (NTS)

E	Change to ramp gradients DL		DL	19/01/2024	
D C	Note 16 Ramp height now 65mm Notes 14 and 15	DL DL		DL DL	14/12/2015 13/05/2014
Rev	Rev Revision details Chkd		Appd	Date	
Drawn: MJA For comment		nent			
Chkd:		For tender		r	
Appd:			Fo	r const	ruction
Date: As constructed		ucted			
File re	ef:				

IWP Ref:


West Sussex County Council Infrastructure Group

County Hall, West Street Chichester West Sussex PO19 1RH (01243) 642105




Ramped paviours to be laid Colour contrasting blocks laid transversely at change in gradient directly onto 150mm freshly laid (unset) C20/20 class 975 width or 1300 width at commencement of shared surfaces except where rest of road is traffic calmed Laid flush 150

(4) BLOCK PAVED ROAD AND RAMP - DIAGRAM 1062 MARKING OMITTED (20mph ZONES ONLY) (NTS)

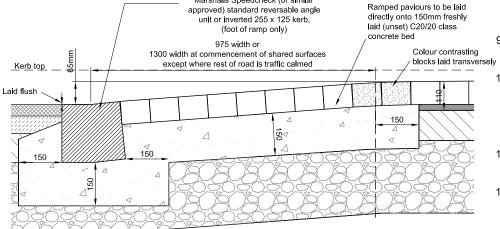

(5) ASPHALT CONCRETE ROAD, BLOCK PAVED RAMP-DIAGRAM 1062 MARKING OMITTED (20mph ZONES ONLY) (NTS)

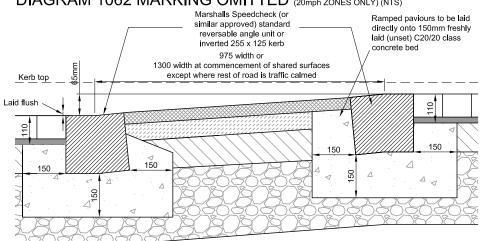

(6) BLOCK PAVED ROAD AND RAMP - WITH DIAGRAM 1062 MARKING (NTS)

NOTES

- Do not scale from this drawing.
- Kerbs to be butt jointed. Where kerb alignments incur 'minor open joint tapers' between formed surfaces mortar jointing shall be used as directed by Highway Inspector.
- All full length PCC kerbs are to be mechanically handled.
- All precast concrete Kerbs & Edgings shall be to BS EN 1340 & laid
- All setts of natural stone shall be to BS EN 1342 & laid to BS 7533-7.
- All Kerbs & Edgings bed & backing forming rumble strip to be Concrete Class ST4 (C16/20), well compacted. Unless otherwise stated this shall be a minimum bed thickness of 150mm.
- 7. The minimum length of any cut kerb shall be 450mm (Half kerb).
- The correct radius kerbs shall be used for all radii of 12m or less. For radii between 12m and 20m 600mm long straight units shall be used. Radius kerbs shall be used to form corners of laybys and tapers.
- The correct transition kerbs shall be used for all drop kerb and upstand variation locations.
- Markings to diagram 1062 may be omitted within 20mph Zones subject to Safety Audit. Ramps shall be designed to be conspicuous to approaching drivers, particularly where markings to diag 1062 are omitted. - This may be achieved through the use of colour contrasting
- 11. Block paved ramped sections are only permissible in 20mph Zones where markings to diag 1062 are omitted.
- 12. Plateau sections of speed tables shall be a minimum of 4m in length, and on through routes, bus routes and spine roads they shall be at
- 13. Speedcheck (or similar) block may be replaced by an inverted $255\,\mathrm{x}$ 125 kerb (laid flush) except at tops of ramps where both ramp face and plateau are block paved.
- 14. Road centre-line markings to diagram 1004 shall be provided over the ramp wherever triangle hump markings to diag 1062 are installed except where there is a controlled pedestrian crossing on the ramp, or when the width of the hump is less than 5m.
- 15. Edge of road markings to diagram 1012.1 shall be placed alongside the ramp wherever triangle hump markings to diag 1062 are installed to indicate the edge of a road hump which does not extend across the full width of the carriageway but ends within 300mm of the kerb-line, except where single or double yellow line markings to diag 1017 or 1018.1 are installed.
- 16. Tables/humps on cambered roads shall match the profile of the underlying road surface

Project Name

Section 278/38 Highway Agreement Standard Details

Drawing Title

Street Furniture Ramp Feature



Original Drawing Size: А3

Scale: NTS Dimensions: mm


Drawing No.


S278/38/16


Rev


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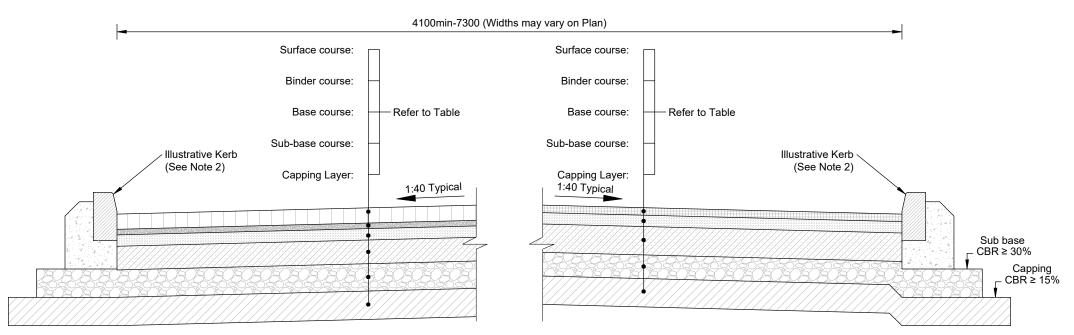




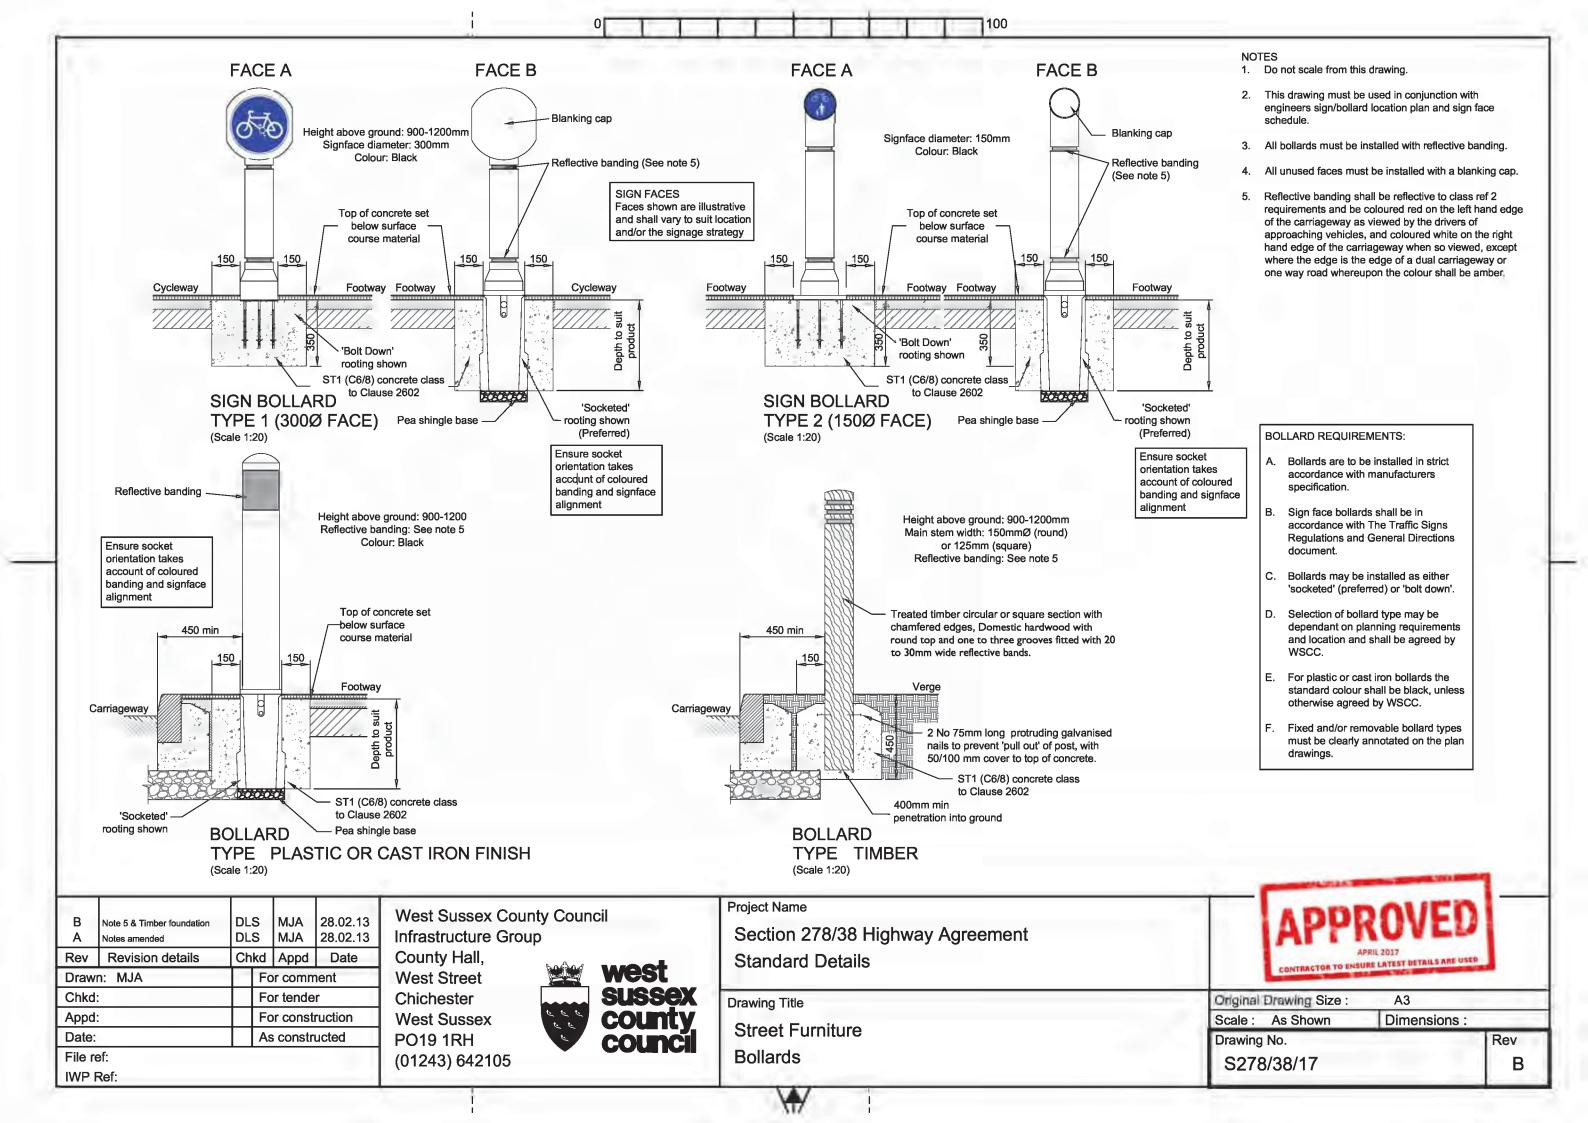

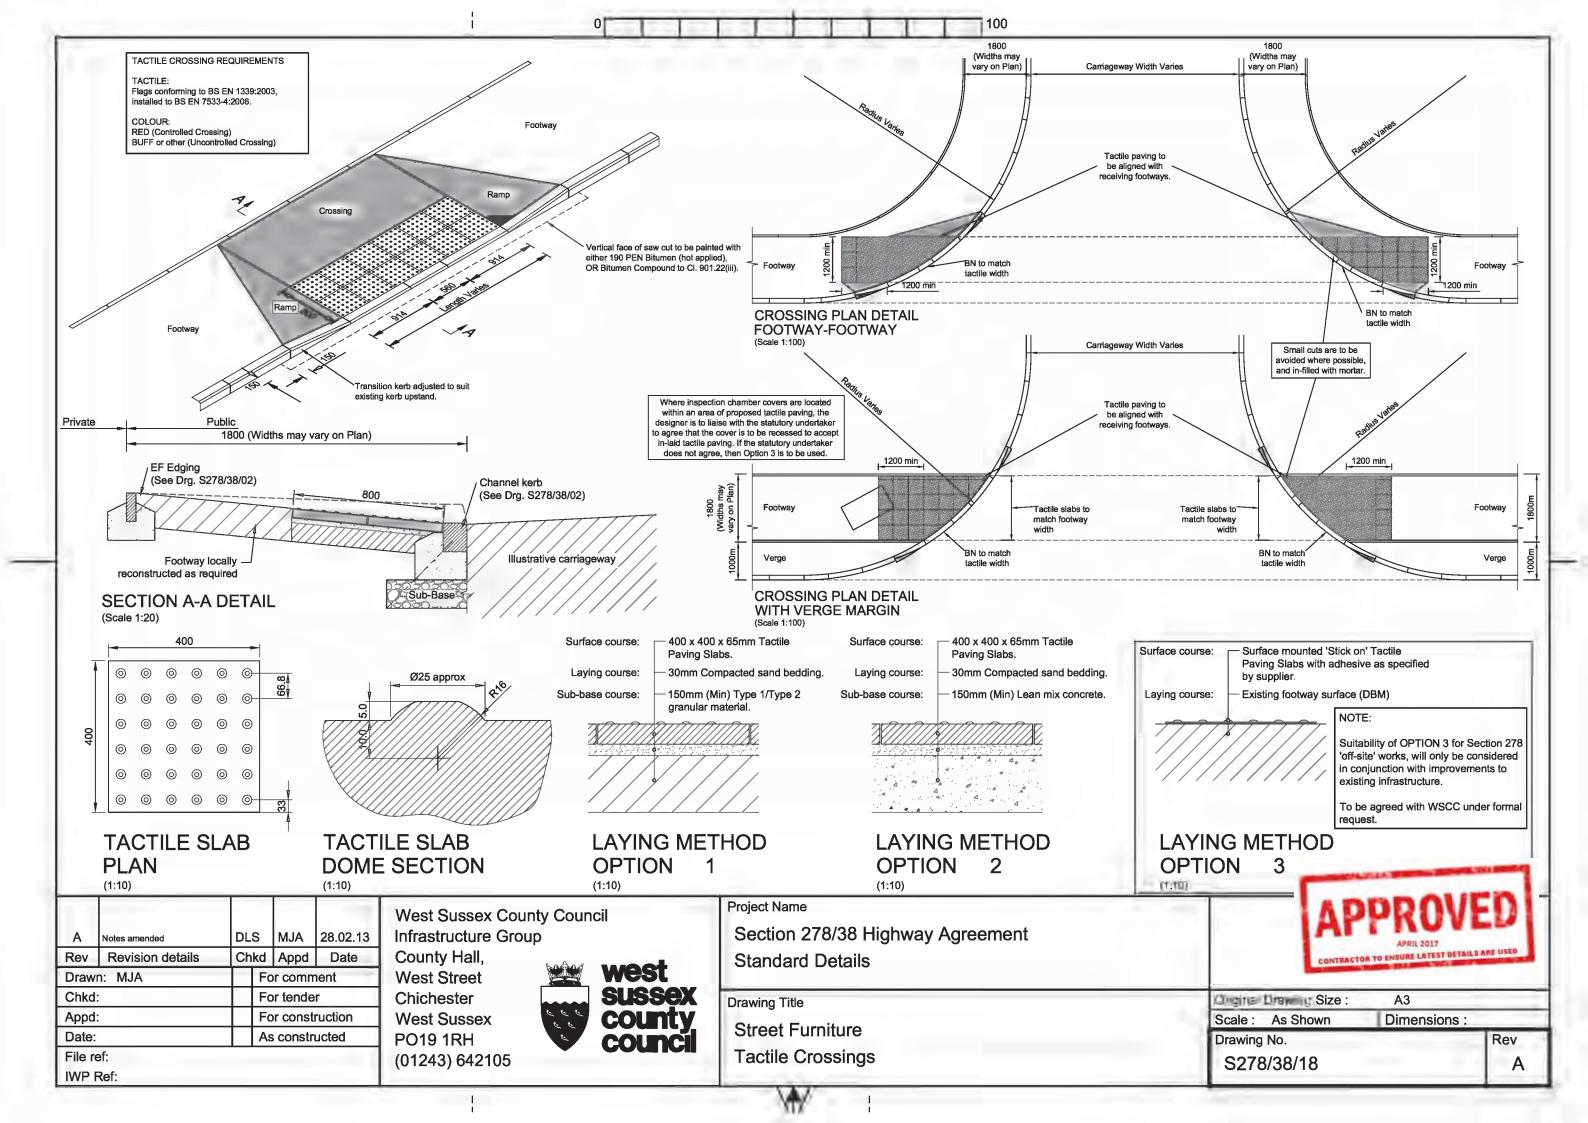

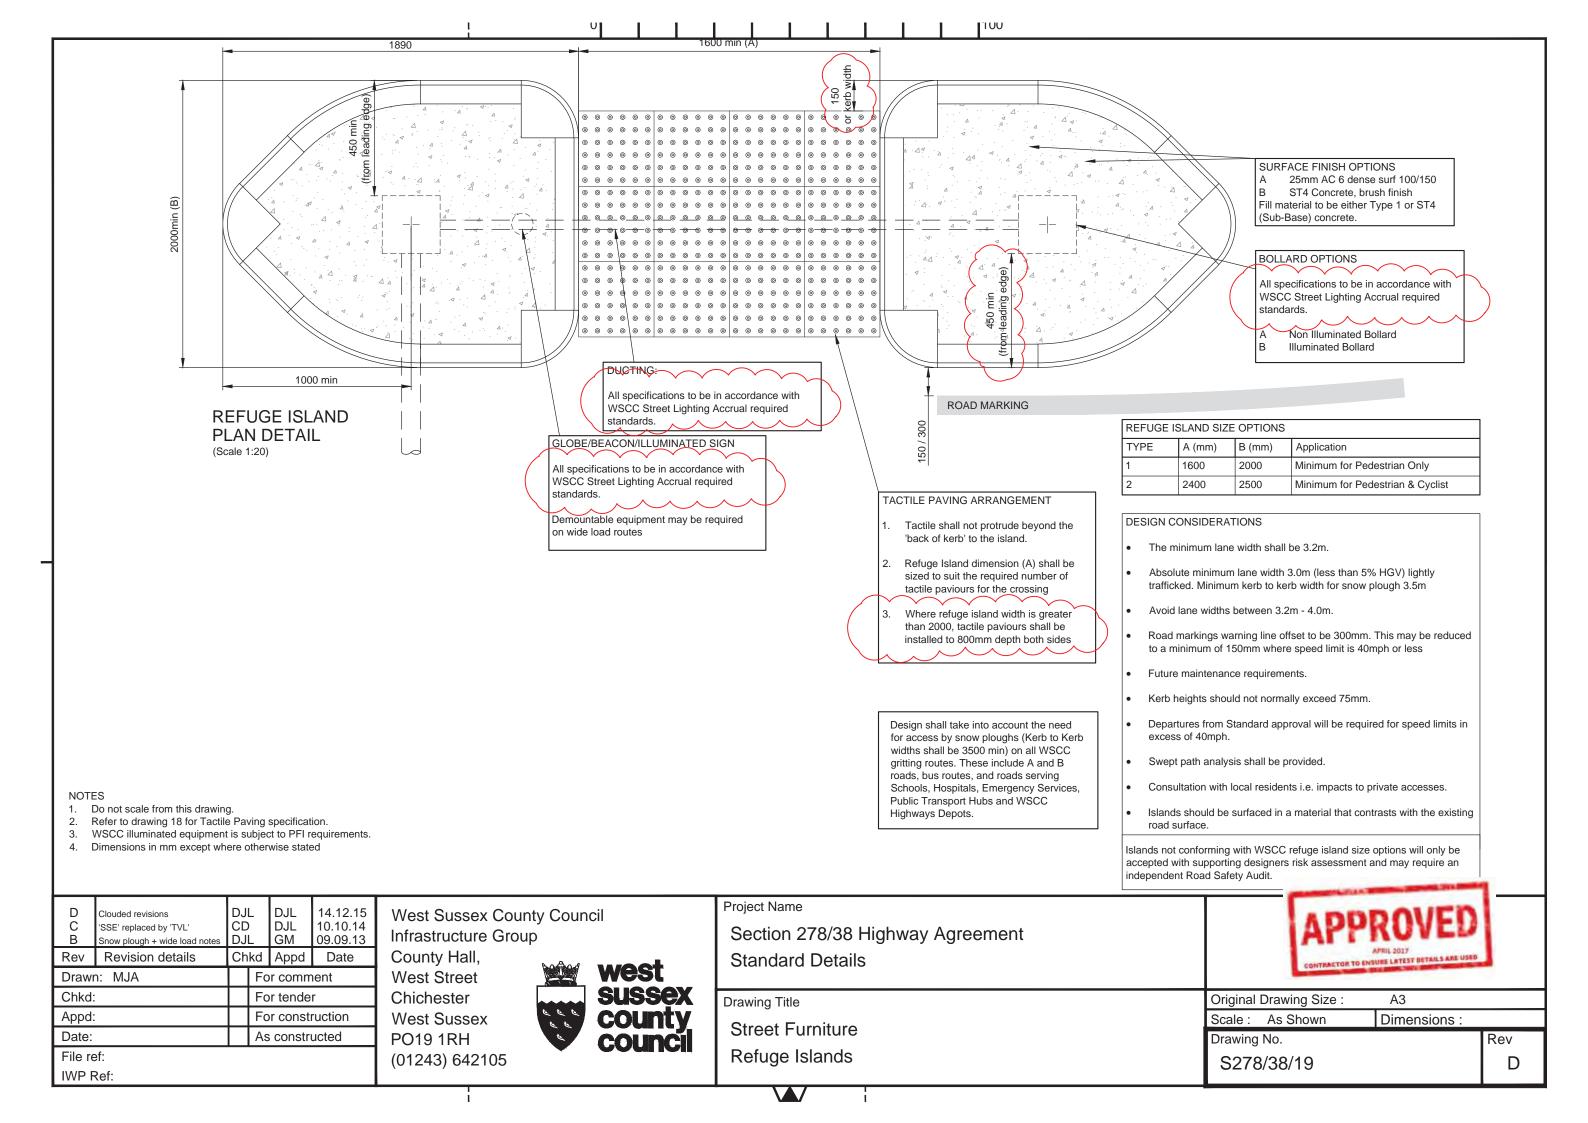

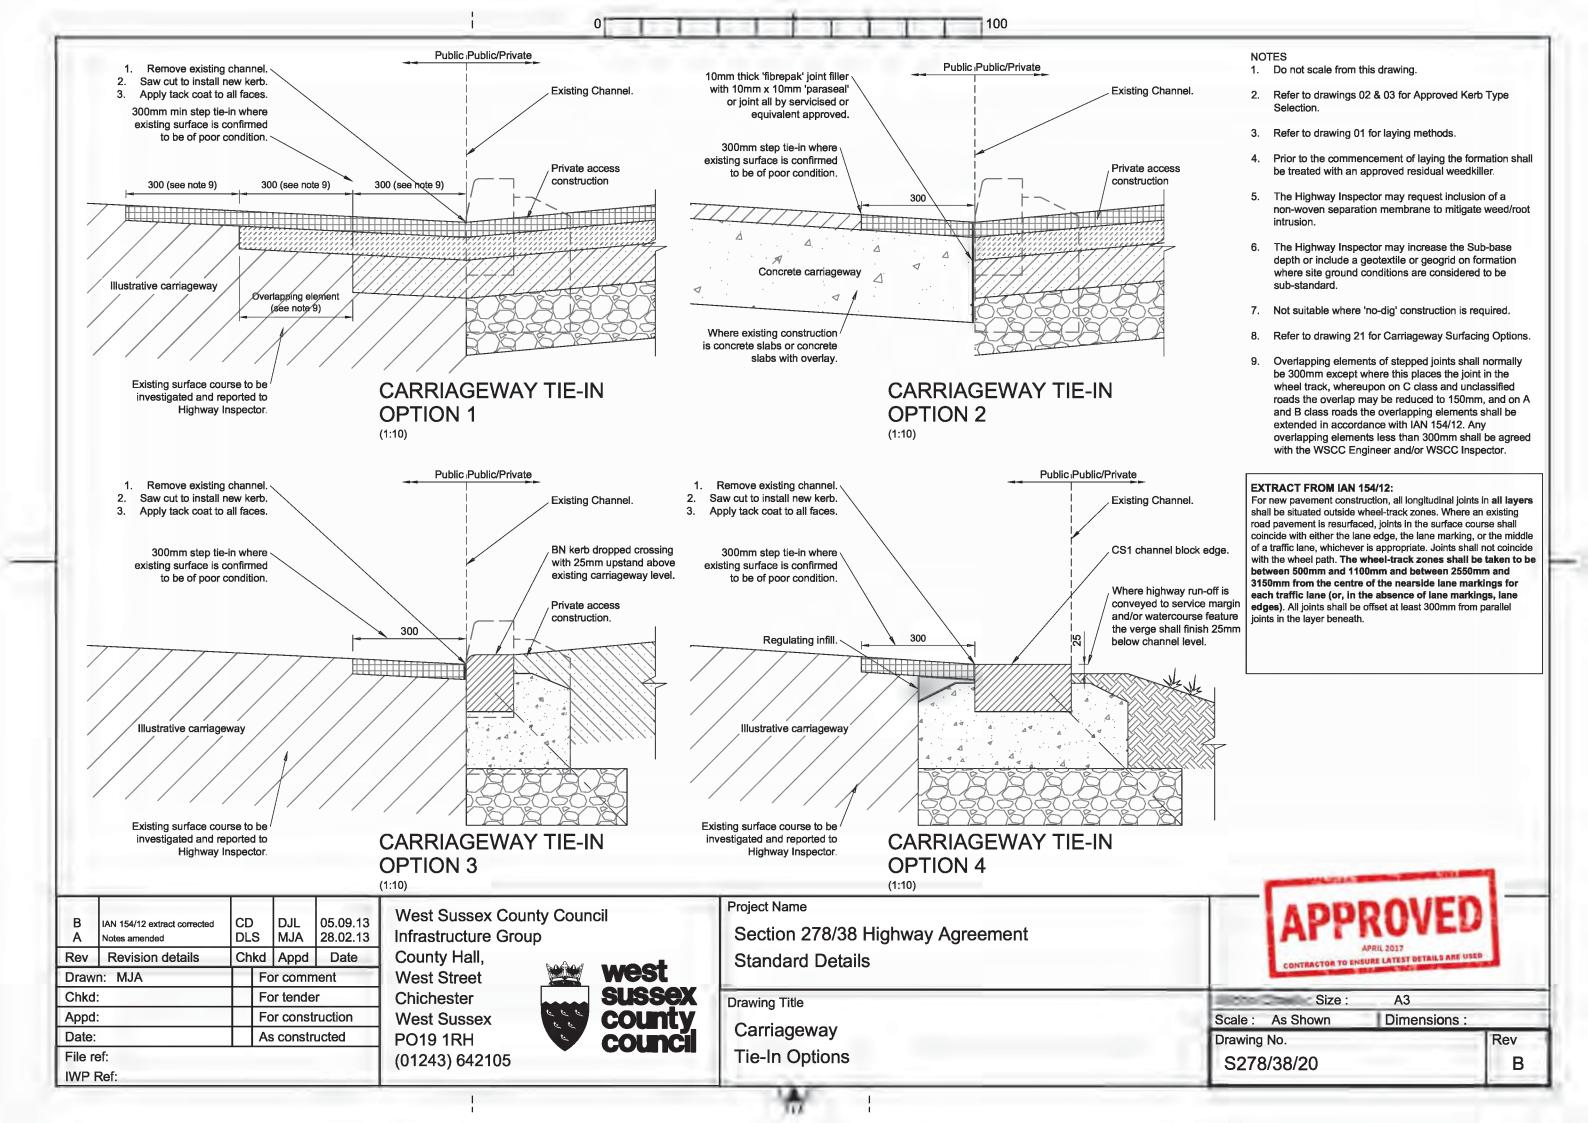

TYPE 1 FLEXIBLE CONSTRUCTION

(Scale 1:20)

HRA Surface Course Binder Spec:

35/14 Hot Rolled Asphalt (Performance Related Design Mix) to cl. 943 in accordance with BS EN 13108-4. PD 6691, BS 594987

HRA 35/14F surf des Course

Aggregate Percentage: 35% Coarse Aggregate to be crushed rock or slag, excluding limestone. Minimum PSV = 50

Aggregate Grading [BS EN 13108-4 Table 4] Column

Test temperature for wheel-tracking to BS 598-110: 45 °C Maximum Wheel-tracking rate: 2 mm

Maximum Wheel-tracking rut depth: 4 mm Site classification: 1

Minimum target Binder Content Bact = 7.0%

HRA Chipping spec:

14/20mm precoated chippings (PSV as per table 3.1a of IAN 156/12*) with a spread rate achieving a texture depth in accordance with Series 900 table 9/3* in accordance with BS EN 13108-4, PD 6691, BS 594987 Coarse Aggregate to be crushed rock or slag, excluding limestone and gravel. Coated Chippings Nominal Size: 14/20. Aggregate Grading to PD 6691 Table C.5 Column No.: 14/20 size. Flakiness Index: F120.

Maximum AAV: 12.

File ref:

IWP Ref:

Minimum Target Binder Content Bact = 1.5%

*DESIGNER TO FULLY SPECIFY MATERIALS WITH APPROPRIATE VALUES FOR TEXTURE DEPTH AND PSV INCLUDED ON CONSTRUCTION DRAWINGS.

ALL CONSTRUCTION LAYER THICKNESSES TO BE FULLY SPEC	CIFIED BY THE DESIGNE	ALL CONSTRUCTION LAYER THICKNESSES TO BE FULLY SPECIFIED BY THE DESIGNER PRIOR TO TECHNICAL APPROVAL					
	LOCAL DISTRIBUTOR See note 14	COLLECTOR 200-300 dwellings	ACCESS ROAD <200 dwellings				
CAPPING LAYER (For Design CBRs ≤ 5% capping shall be	oe class 6F1/6F2 (site v	von), or 6F4/ 6F5 (im	ported) material.				
Design CBR <2%	Bespoke design	Bespoke design required in accordance with IAN 73/06					
Design CBR 2-2.5%	600	600	600				
Design CBR >2.5-5%	350	350	350				
Design CBR >5% (Type 1 to Clause 803)	100	100	100				
Requirements for determination of the Design CBR are located	ed on our website: www	v.westsussex.gov.uk/	roadagreements				
SUB-BASE							
Type 1 (Clause 803)	150	150	150				
BASE							
Either: 32mm Dense Asphalt Concrete Base 40/60 PEN to cl.906	150	125	100				
Or: Lean Mix Concrete	-	150	150				
BINDER							
20mm Dense Asphalt Concrete Binder 40/60 PEN to cl. 906 (Not required with block paviours)	60	60	60				
SURFACE COURSE							
HRA 35/14 F Surf des course to cl.943 with 14/20mm pre-coated chippings. See specification (left)	50	-	-				
10mm Close Graded Asphalt Concrete Surface Course 100/150 to cl.912. Designer to specify PSV and AAV	-	30	30				
Blocks on 30mm sand Bed	-	80	80				

- Do not scale from this drawing.
- Refer to drawings 02 & 03 for Approved Kerb Type Selection.
- Refer to drawing 01 for laying methods.
- Prior to the commencement of laying the formation shall be treated with an approved residual weedkiller.
- The Highway Inspector may request inclusion of a non-woven separation membrane to mitigate weed/root intrusion.
- The Highway Inspector may increase the Sub-base depth or include a geotextile or geogrid on formation where site ground conditions are considered to be sub-standard.
- Not suitable where 'no-dig' construction is required.
- Asphalt Concrete to be in accordance with BS EN 13108-01 and BS
- Type 1 Sub-base to be in accordance with Specification for Highway Works clause 803.
- 10. Hot Rolled Asphalt to be in accordance with BS EN 13108-04 and BS 594987.
- 11. Block Paviours to be in accordance with BS EN 1338 and BS 7533-3:2005 (A1:2009).
- 12. Total Carriageway construction depth must be greater than 450mm to negate susceptibility to frost penetration, irrespective of CBR value.
- 13. Where block paved construction is proposed the binder course may be
- 14. More major roads (A or B class roads) shall have a bespoke pavement design in accordance with DMRB standards.
- 15. Carriageway widening to widths of less than 1m; Base and sub-base to be replaced with ST1 concrete with the same overall construction depth as the
- 16. Under some circumstances, WSCC may accept 40mm of Bardon Superflex 50 with 10mm Aggregate (65 PSV) as a surface course, provided there is a 10 year guarantee on the skid resistance value (SRV).
- 17. WSCC may accept 45 +/- 5mm of Bardon Superflex 72 with 10mm Aggregate as a surface course in lieu of a standard surface course with HFS subject to site specific approval.
- 18. PSV shall be declared in accordance with IAN 156/12 table 3.1a.
- 19. CBR values to be obtained from site investigation report and laboratory testing only. In-situ testing shall not be used to determine or amend the design CBR. The WSCC Inspector may request additional tests. In situ CBR tests shall only be used to confirm that the design CBR is met and to identify 'soft spots' in the construction.
- 20. Capping shall be class 6F1/6F2 (site won) or 6F4/6F5 (Imported)
- 21. WSCC does not permit lime/cement stabilised material in capping or sub
- 22. Block paviours shall, where the chosen brick shape is suitable, be laid in herringbone pattern at 45° to the direction of travel, except where the WSCC Inspector has granted approval in writing to deviate from this
- 23. High Friction Surfacing shall be HAPAS approved Type 1 (cold applied) with MMA binder. See also note 17.

ALTERNATIVE DESIGN: WSCC will accept permanent foundation designs in accordance with the latest revision of Interim Advice Note 73/06

FEDC	Note 23+HRA/Binder Thickness HRA spec, CBR notes Note 20+21, Capping thickness Various revisions	DJL DJL NA DJL		DJL HM DJL DJL	16.11.17 13.03.17 26.05.16 14.12.15
Rev	Revision details	Ch	kd	Appd	Date
Drawi	n: MJA	For comment		nent	
Chkd:		For tender		r	
Appd:		For construction		ruction	
Date:		As constructed		ucted	

West Sussex County Council Infrastructure Group

County Hall, West Street Chichester West Sussex PO19 1RH (01243) 642105



Project Name

Section 278/38 Highway Agreement Standard Details

Drawing Title

Carriageway Flexible Specification




Original Drawing Size: A3

Scale: As Shown Dimensions: Drawing No.

S278/38/21



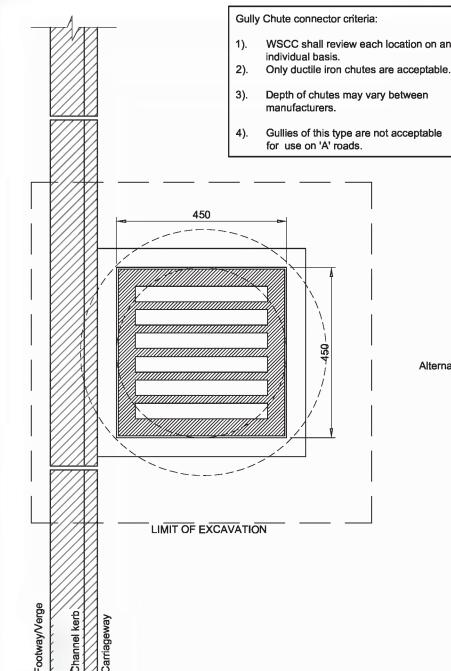

Illustrative channel kerb. Kerb to be adjusted to sit on brickwork. Cover & Frame (See Notes 2 - 4): Cover depths for gullies: Footway/Verge 'B' roads and unclassified highways 100mm. 'A' roads and higher 150mm Carriageway 450 Mortar bed 350 (See Note 4) 450 nominal Outlet Pipe Alternative gully pots are subject to approval from WSCC. 150mm Insitu concrete bed & surround min grade ST4 (C16/20) to gully pot. 12mm thk. compressible filler board, or pre-formed joint filler for full thickness of concrete bed and surround. 150mm Ø outlet pipe surrounded

GULLY C

TYPE: CHUTE (SUMPLESS)

GULLY C

TYPE: CHUTE (SUMPLESS)

SECTION

(1:10)

- 1. Do not scale from this drawing.
- 2. All gully grating and frames to be 'hinged' heavy duty ductile iron minimum grade D400 in accordance with BS EN124:1994 & Section 508 of the Specification of Highway Works.
- 3. All ironwork shall carry a BSI kite mark.
- Frames shall be bedded on a gauged Class 1 (3:1) sand/cement mortar to Cl.2402 of SHW Mortar Designtation (i), and either 2 or 3 courses of Engineering Brickwork Class 'B' to BS EN 771-1:2011.
- Gully spacing is to be determined from the requirements of HA 102/00, Design Manual for Roads and Bridges, however, maximum area to be drained by one gully: 180 m²
- 6. Gully pots used for carriageway gullies shall be of precast concrete using Sulphate Resisting Cement (SRC) in accordance with BS 5911, part 230, 2004.
- 7. Selection of gully grating type shall be to suit the application area i.e carriageway, footway/cycleway and to the satisfaction of the highway inspector.
- Pipe bedding to highway drainage to be Type Z when located under carriageway, and Type T at all other times, as detailed on Specification of Highway Works HCD no. F1.
- For surface water pipe specifications, refer to Drg. No. S278/38/11.

PLAN

Chkd Appd

For comment

For construction

As constructed

For tender

Date

(1:10)

Revision details

Rev

Chkd:

Appd:

Date:

File ref:

IWP Ref:

Drawn: DLS

West Sussex County Council Infrastructure Group

County Hall, **West Street** Chichester **West Sussex** PO19 1RH

(01243) 642105



Project Name

Section 278/38 Highway Agreement Standard Details

with 150mm ST4 (C16/20) concrete down to depth of cover of:

(Carriageway)

(Footway/Verge)

1200mm

900mm

Drawing Title

Drainage

Gully C - Chute Gully (Sumpless)




Chigina Drawing Size:

A3

Scale: As Shown Dimensions: Drawing No.

S278/38/22



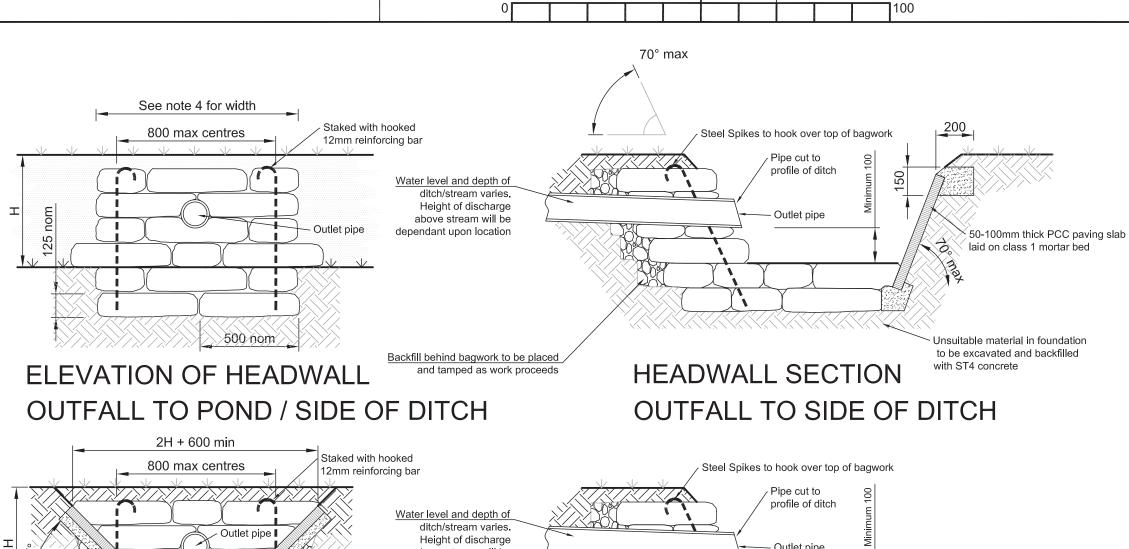

HEADWALL SECTION OUTFALL TO POND / END OF DITCH

Unsuitable material in foundation

to be excavated and backfilled

with ST4 concrete

NOTES

- 1. Bags shall be of Hessian or Canvas and shall be of a size to provide a wall thickness of 500mm
- 2. Concrete bagwork shall be to Clause 519 and be three quarter filled with 25mm slump ST4 concrete immediately prior to placing with the ends sewn.
- 3. The bags shall be placed in a modified Flemish bond so as to 'break joint' with the mouths away from the surface and be tamped into position to form a rectangular block
- 4. Extent of outlet protection to be the greater of 1500mm or pipe diameter + 1200mm spanning the outlet pipe.
- 5. Headwall design may need to be adjusted to on site conditions following approval from WSCC Inspector
- 6. For vehicluar crossings of ditches pipes shall be min 450mm diam and be set to invert of ditch. Ditch to be regraded to achieve satisfactory falls.
- 7. For H>600 appropriate vehicular or pedestrian containment shall be installed.
- 8. The nearest edge of any carriageway shall be set back at least H from the base of the ditch
- 9. All exposed pipework to be certified UV stable.

					_
А	Note 9 added	D)L	НМ	25.04.17
Rev	Revision details	Ch	kd	Appd	Date
Drawı	n: DJL	For comm		r comm	nent
Chkd:	GM	For tender		r	
Appd:	AH	X For constru		ruction	
Date:	SEPT 2013	As constructed		ucted	

File ref: IWP Ref:

West Sussex County Council Infrastructure Group County Hall,

above stream will be dependant upon location

Backfill behind bagwork to be placed

and tamped as work proceeds

West Street Chichester West Sussex PO19 1RH (01243) 642105

50-100mm thick PCC paving slab laid on 50mm

class 1 mortar bed

500 nom

ELEVATION OF HEADWALL

OUTFALL TO END OF DITCH



Project Name

Section 278/38 Highway Agreement Standard Details

Outlet pipe

Drawing Title

Headwall Detail for pipe sizes up to 600 diam Concrete Bagwork




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Scale: 1:20 Dimensions: mm Drawing No.

S278/38/23




100

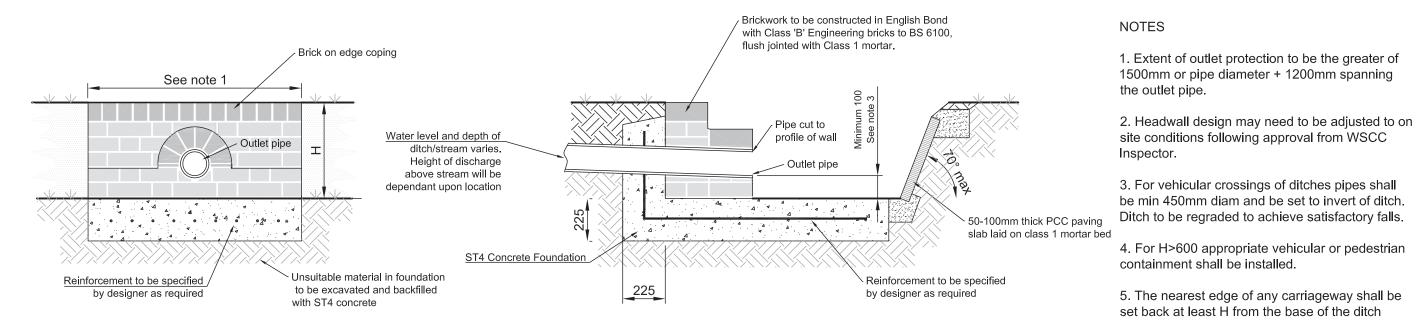

ELEVATION OF HEADWALL OUTFALL TO POND / SIDE OF DITCH

HEADWALL SECTION OUTFALL TO SIDE OF DITCH

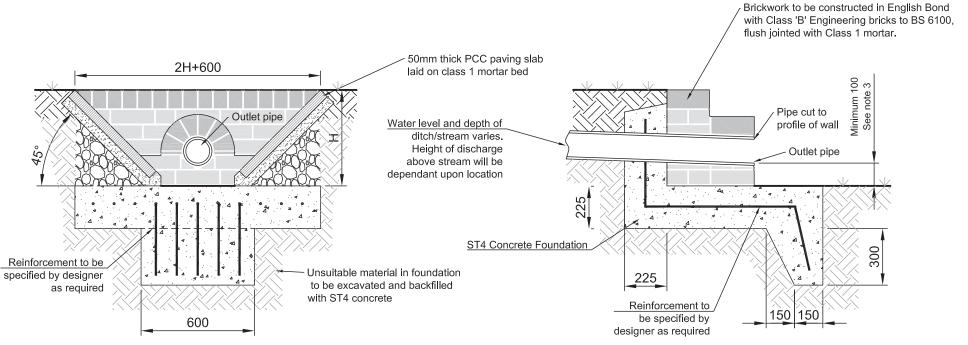

ELEVATION OF HEADWALL OUTFALL TO END OF DITCH

HEADWALL SECTION OUTFALL TO POND / END OF DITCH

Α	Note 6		JL	НМ	25.04.17
Rev	Revision details	Ch	kd	Appd	Date
Drawı	n: DJL		Fo	r comm	ent
Chkd:	GM	For tender			r
Appd:	AH	X For construction		ruction	
Date:	SEPT 2013		As	constr	ucted
F31					

File ref: IWP Ref:

West Sussex County Council Infrastructure Group County Hall,

West Street Chichester West Sussex PO19 1RH (01243) 642105



Project Name

Section 278/38 Highway Agreement **Standard Details**

Drawing Title

Headwall Detail for pipe sizes up to 600 diam **Engineering Brickwork**




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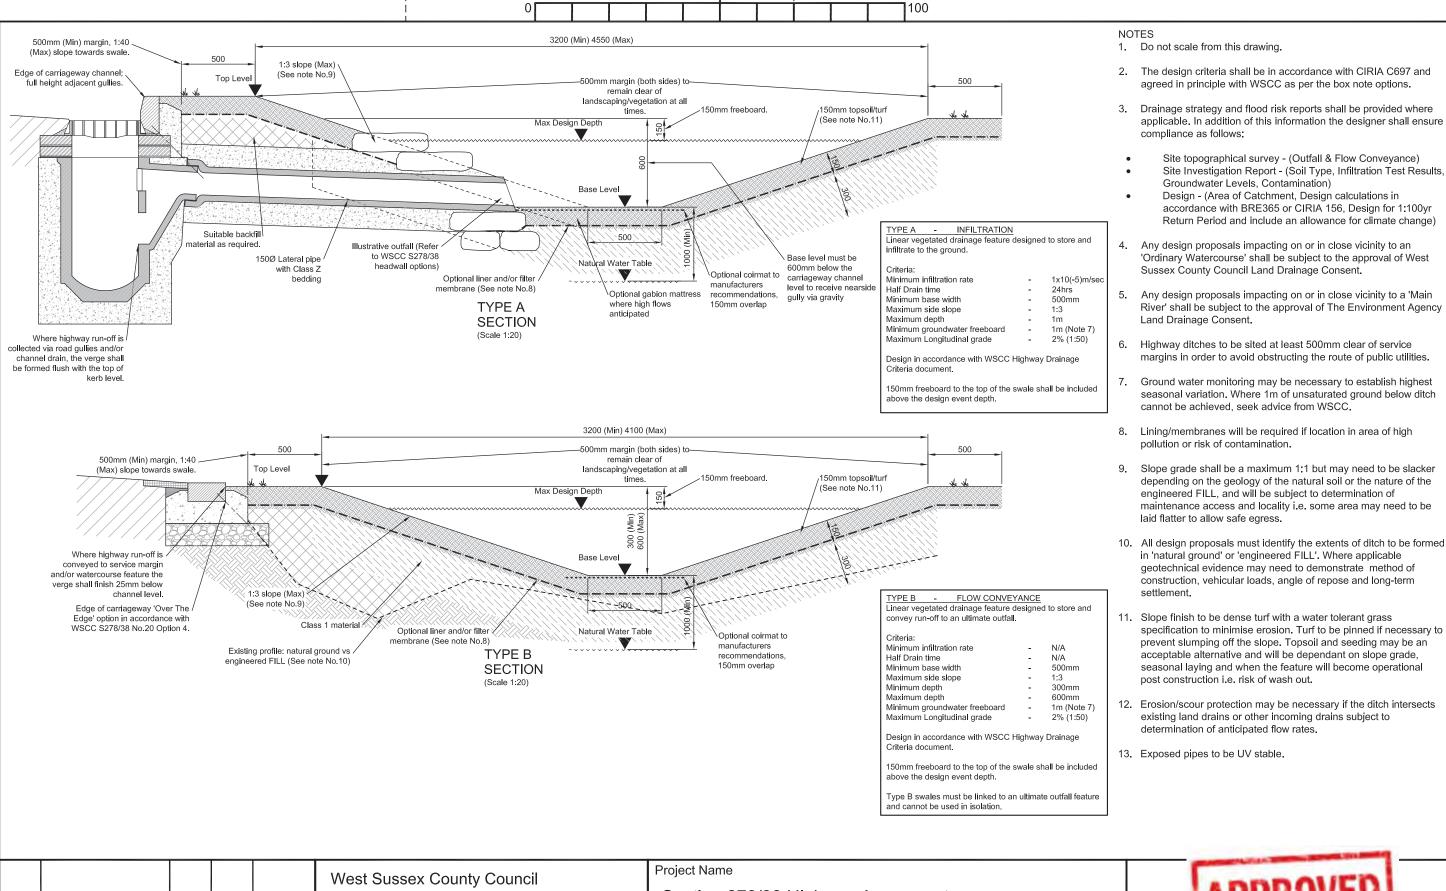
S278/38/24

6. All exposed pipework to be UV stable

Scale: 1:20 Dimensions: mm Drawing No. Rev





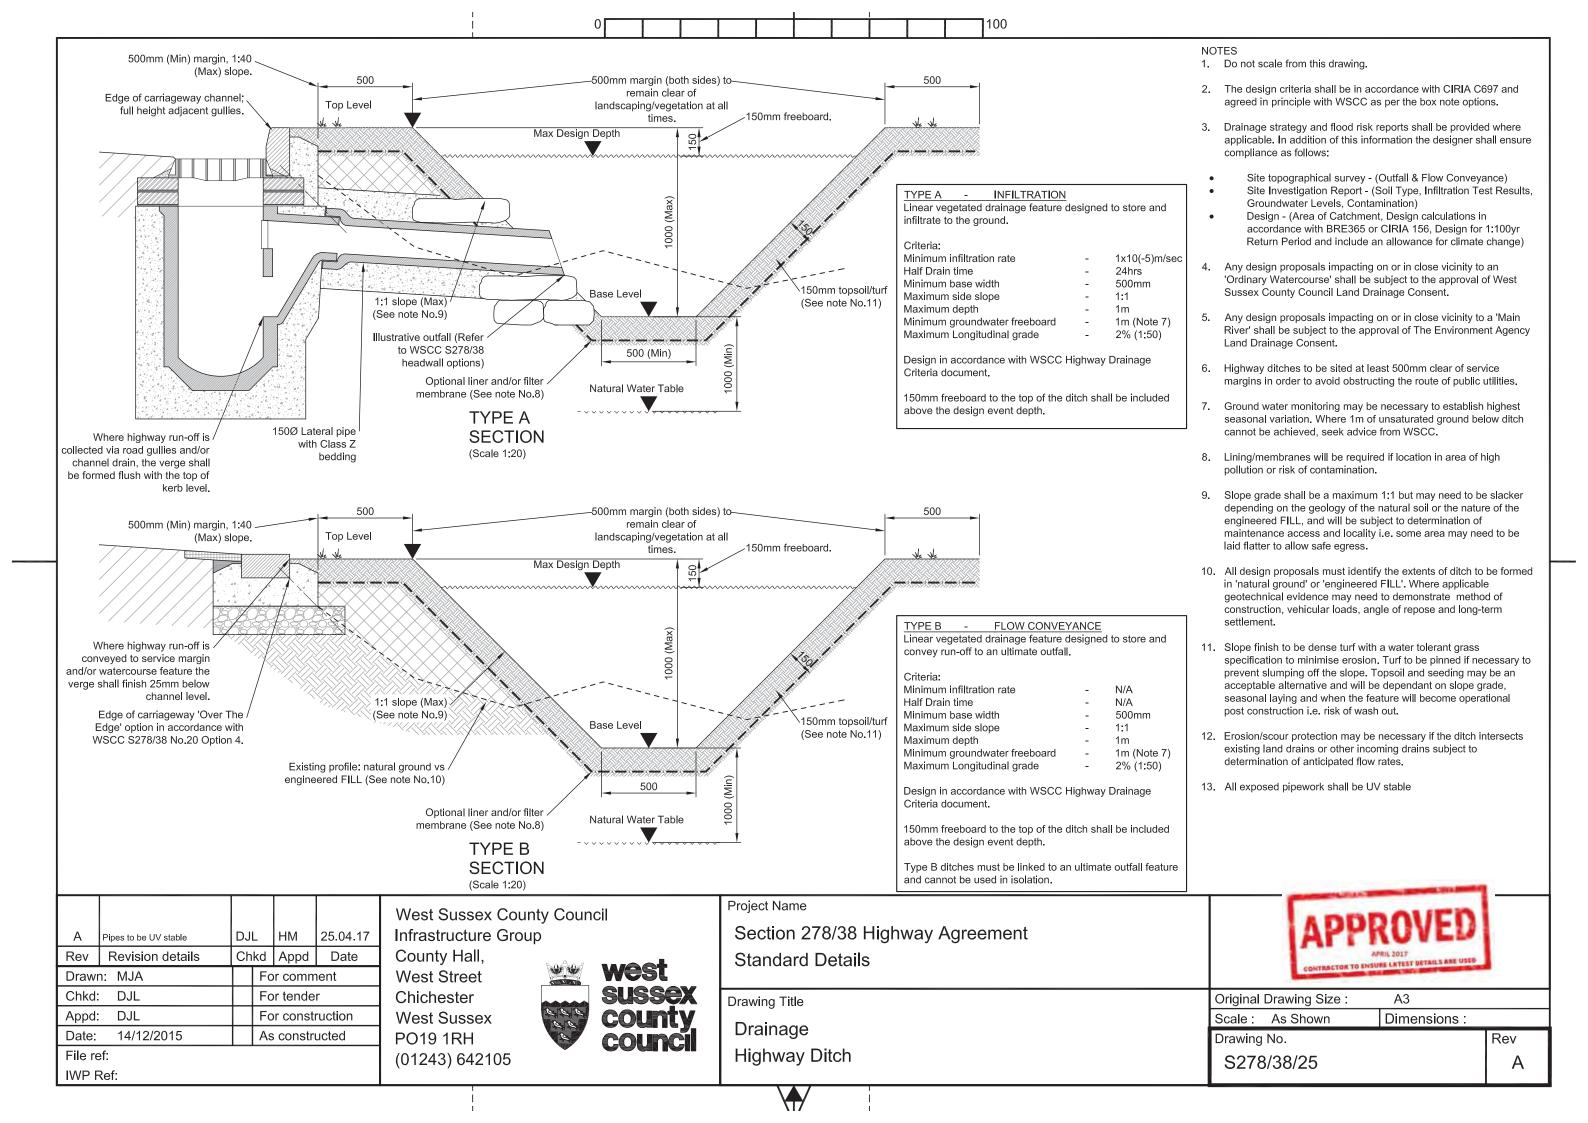

25.04.17 НМ Note 13 Revision details Chkd Appd Date Rev Drawn: MJA For comment Chkd: DJL For tender DJL For construction Appd: 14/12/2015

As constructed

File ref: IWP Ref:

Date:

Infrastructure Group County Hall, West Street Chichester West Sussex PO19 1RH

(01243) 642105

Section 278/38 Highway Agreement Standard Details

Drawing Title Drainage

Highway Swale



Α3

Original Drawing Size :


Scale: As Shown Dimensions:

Drawing No.

S278/38/26

Rev Α



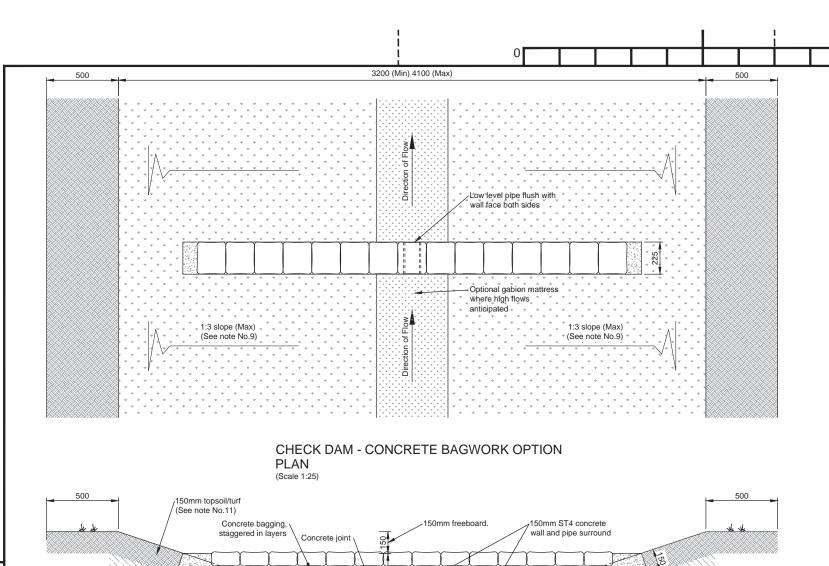

CHECK DAMS

To be provided where longitudinal grades cannot be laid flatter than 2%.

100

NOTES

1. Do not scale from this drawing.

2. Refer to drawing 26 for swale Type Selection and specifications.

- Heights shall be 150mm below the top of swale (*).
- (*) To be provided at intervals of 10-20m to ensure the upstream toe water level matches the downstream dam. WSCC may require a long section to demonstra appropriate spacing.

Permitted Types: Gabion Wall

- Concrete Bagwork
 Earth berm (CLAY Core)

Loose aggregate and/or wooden boards are not accepted.

All check dams shall include a low level pipe (weep hole) to maintain baseline flows. Only 100Ø, 150Ø or 225Ø pipe sizes are permitted and will be subject to hydraulic assessment of flow rates.

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Rev	Revision details	Ch	kd	Appd	Date
Drawı	n: MJA		For com		nent
Chkd:	DJL		For tender		r
Appd:	DJL		For construction		ruction
Date:	14/12/2015		As	constr	ucted
File re	ef:				

150mm ST4

SECTION

(Scale 1:25)

concrete bedding

IWP Ref:

West Sussex County Council Infrastructure Group

CHECK DAM - CONCRETE BAGWORK OPTION

County Hall, West Street Chichester West Sussex PO19 1RH (01243) 642105



Project Name

Section 278/38 Highway Agreement **Standard Details**

Drawing Title

Drainage

Highway Swale Check Dam



Original Drawing Size:


A3


Scale: As Shown

Dimensions:

Drawing No. S278/38/27




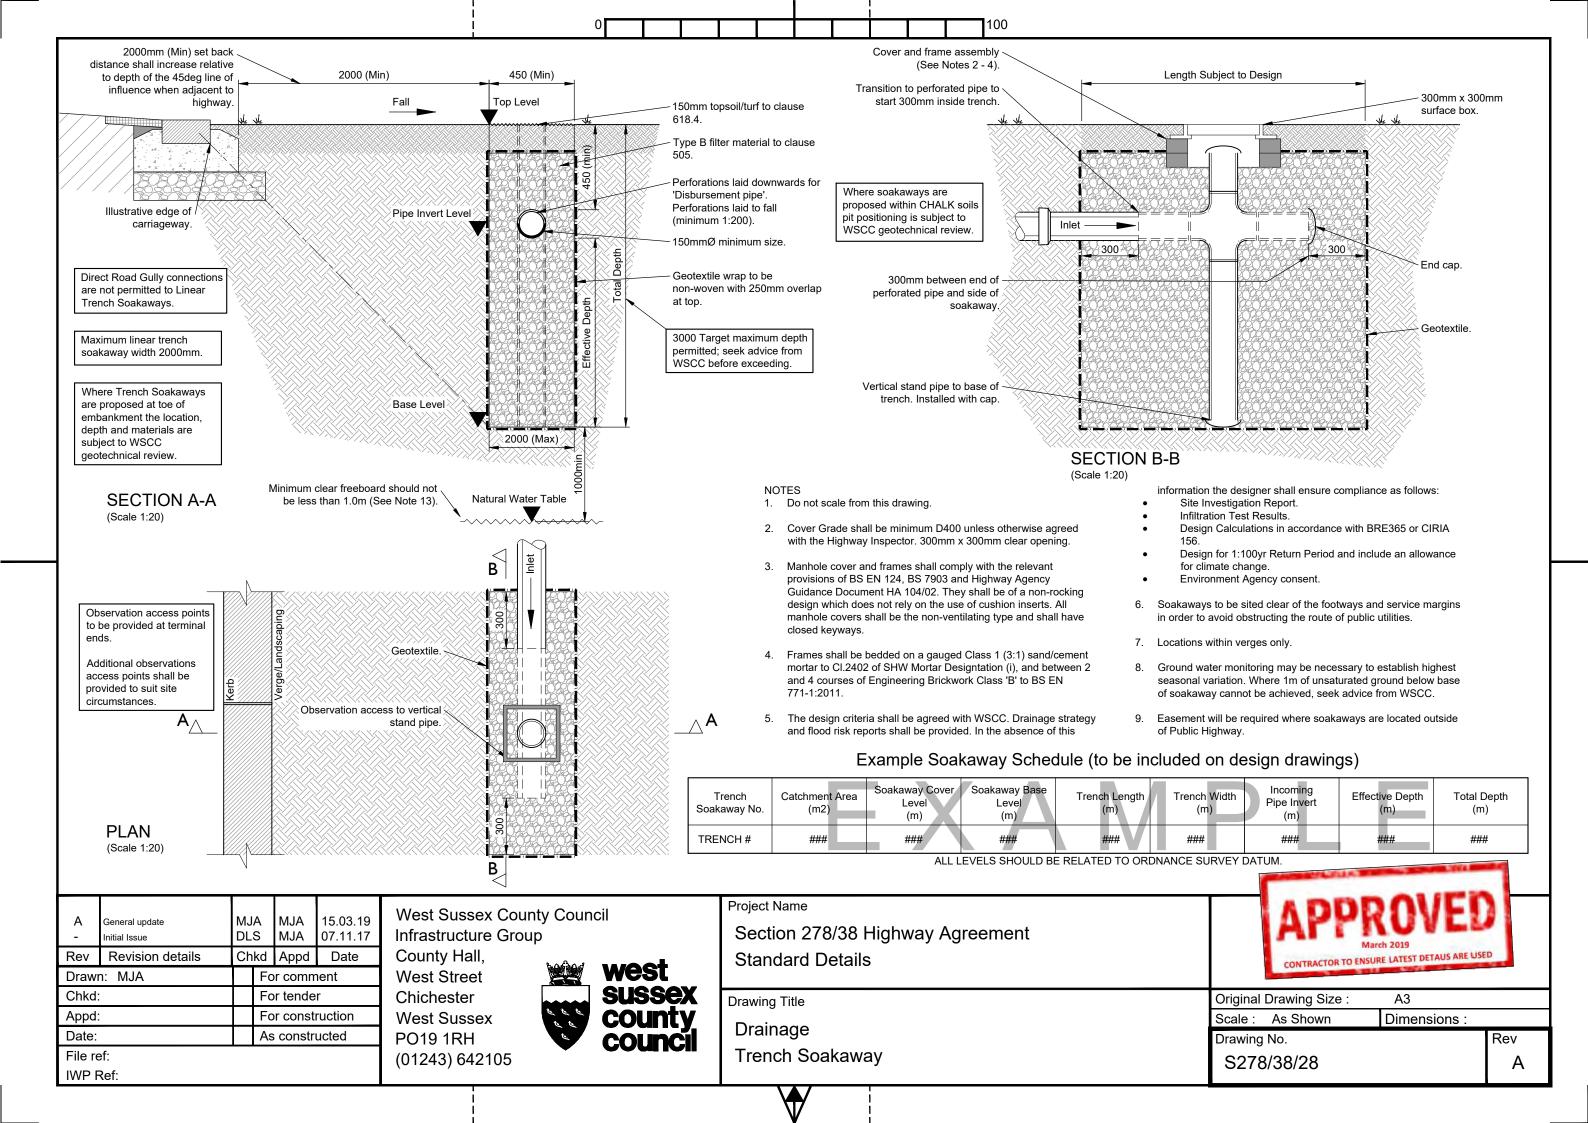

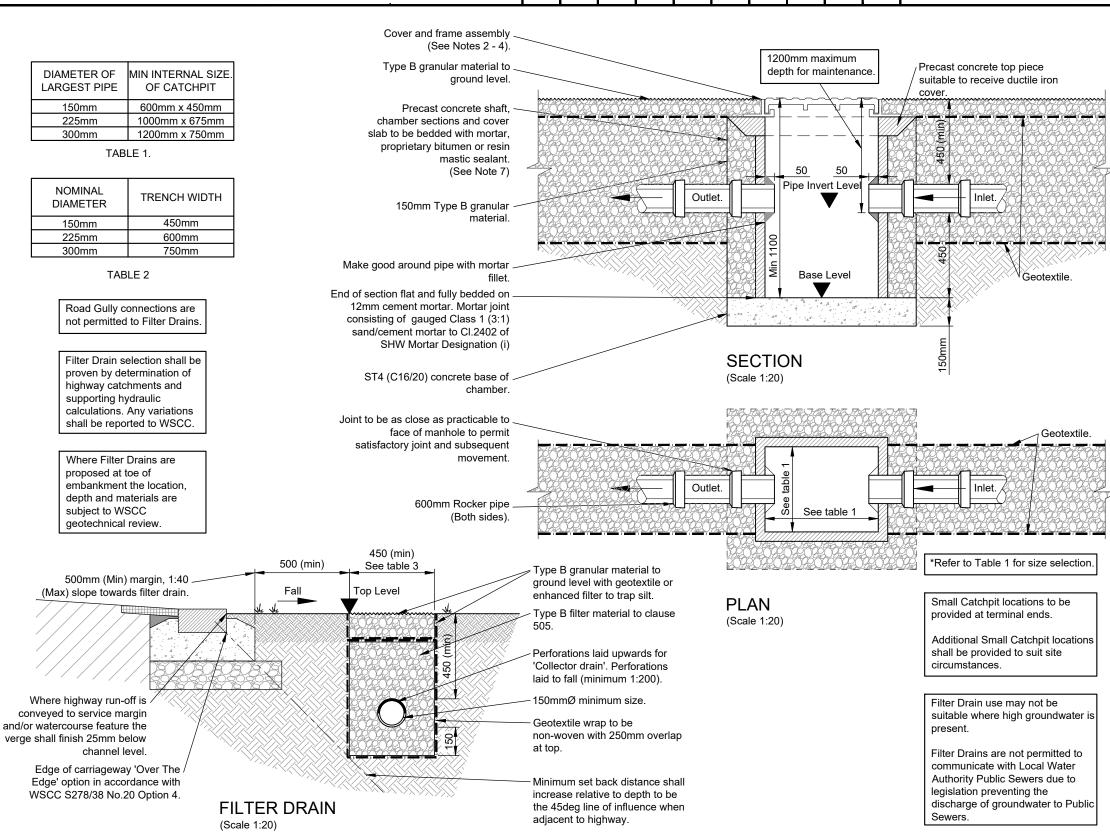

NOTE

- 1. Do not scale from this drawing.
- 2. Cover Grade shall be minimum D400 unless otherwise agreed with the Highway Inspector.
- 8. Manhole cover and frames shall comply with the relevant provisions of BS EN 124, BS 7903 and Highway Agency Guidance Document HA 104/02. They shall be of a non-rocking design which does not rely on the use of cushion inserts. All manhole covers shall be the non-ventilating type and shall have closed keyways. All covers formed of double triangular units shall be loosely bolted together.
- Frames shall be bedded on a gauged Class 1 (3:1) sand/cement mortar to Cl.2402 of SHW Mortar Designation (i), and between 2 and 4 courses of Engineering Brickwork Class 'B' to BS EN 771.1:2011
- Pre-cast concrete products shall comply with the relevant provisions of BS 5911: Part 2, 200 & 230.
- 6. The number of incoming branches and invert levels may vary.
- 7. Min pipe diameter for Filter Drains to be 150mm.
- 8. Max pipe diameter for Filter Drains to be 300mm. (Any variations shall be reported to WSCC).
- Filter Drain pipe specification shall comply with West Sussex County County standard details S278/38/11 'surface water pipes'.

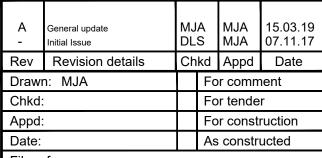

File ref:

West Sussex County Council Infrastructure Group

County Hall, West Street Chichester West Sussex PO19 1RH (01243) 642105



Project Name

Section 278/38 Highway Agreement Standard Details

Drawing Title

Drainage

Filter Drain Collector



Original Drawing Size : A

Scale: As Shown Dimensions:

Drawing No. S278/38/29

Rev A



generated by the public highway (carriageway and adjacent

Design in accordance with WSCC Highway Drainage Criteria

Floor levels of dwellings must be a minimum of 300mm above lowest

Plans showing design exceedance/failure flood/flow routes to be

Permeable paving system to be installed in strict accordance with

3rd Party service apparatus is not permitted within permeable

pavement. Where services need to cross the permeable pavement a

2m wide Service Crossing shall be provided across the carriageway,

Stretcher course adjacent to all kerbs and ironwork.

provided demonstrating no flood risk to dwellings.

manufacturers guidance and recommendations.

Observation chamber to be provided at all low points.

constructed using traditional methods (Refer to section).

2.5% (1:40)

100yr + climate change

1x10-7m/s

24 hours

270mm

4% (1:25)

1.67% (1:60)

90° herringbone

100mmx50mm

footways).

Criteria:

Half Drain time

Rainfall critera

Laying pattern

document

Minimum block size

permeable road level


Crossfall (hung roads only) Minimum infiltration rate

Minimum sub base depth

Minimum groundwater freeboard

Maximum Longitudinal grade

Minimum Longitudinal grade

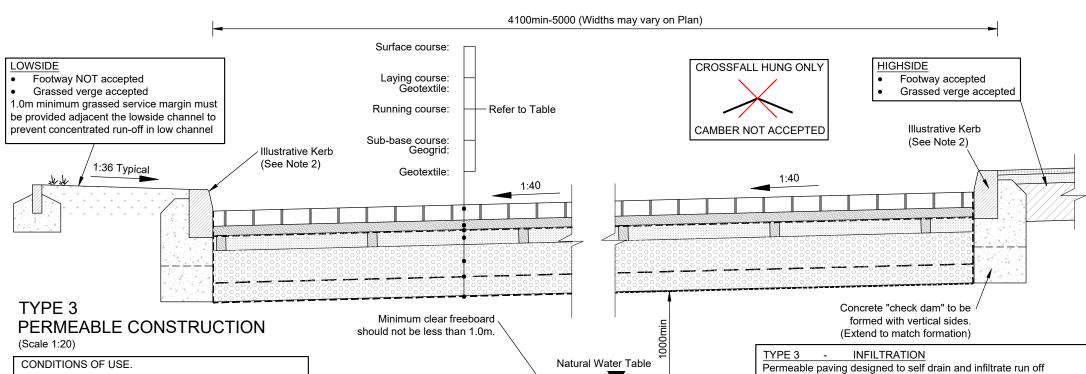

is subject to site suitability including but not limited to the following:-

serving more than 50 dwellings.

Surface material to be BLOCK PAVING only.

Tanked permeable paving will not be permitted.

speed road (20-30mph) and shared surfaces.

• The use of permeable paving must be agreed with

West Sussex County Council by early consultation and

Permeable paving can be selected for cul-de-sac's, low

- Permeable paving will not be accepted on A and B Class roads, bus routes, industrial roads, 'through roads', roads subject to excessive leaf litter or roads
- A relevant geotechnical assessment must be provided including infiltration testing at a depth commensurate with formation level and in subsoil and ground water level monitoring during the wet winter period (October
- The soil infiltration rate must be better than 1x10-7m/s.
- It is unlikely that permeble paving will be permitted if the design CBR is less than 4%.
- Minimum 1m freeboard to base from formation to highest groundwater level.
- Environment Agency approval to the use of permeable paving will be required if the groundwater is sensitive to pollution.

CARRIAGEWAY CONSTRUCTION THICKNESSES
ALL CONSTRUCTION LAYER THICKNESSES TO BE FULLY SPECIFIED BY THE
DESIGNER PRIOR TO TECHNICAL APPROVAL

DESIGNER TRIOR TO TECHNICAL AT TROVAL	
Layer/Material	Layer thickness
Geotextile - Inbitex	
Sub base Type 3 (Clause 803)	Min 270 subject to storage (based on a CBR of 4% or more)
Geogrid SC Intergrid 100mm above formation	
Running surface 80mm thick AC20 Dense Bin (cleaned and perforated with 20 - 50mm diameter holes at 800mm centres and at all low points prior to installing laying course and blocks, holes filled with laying course material)	115
Geotextile - Inbitex	
Laying course 2-6mm clean stone	50
Surface Course Permable Blocks	80

Not suitable where 'no-dig' construction is required.
 Asphalt Concrete to be in accordance with BS EN 13108-01 and BS.

1. Do not scale from this drawing.

approved residual weedkiller.

Refer to drawing 01 for laying methods.

membrane to mitigate weed/root intrusion.

Type 3 Sub-base to be in accordance with Specification for Highway Works clause 803.

Prior to the commencement of laying the formation shall be treated with an

5. The Highway Inspector may request inclusion of a non-woven separation

2. Refer to drawings 02 & 03 for Approved Kerb Type Selection.

Block Paviours to be in accordance with BS EN 1338 and BS 7533-3:2005 (A1:2009).

 Total Carriageway construction depth must be greater than 450mm to negate susceptibility to frost penetration, irrespective of CBR value.

11. CBR values to be obtained from site investigation report and laboratory testing only. In-situ testing shall not be used to determine or amend the design CBR. The WSCC Inspector may request additional tests. In situ CBR tests shall only be used to confirm that the design CBR is met and to identify 'soft spots' in the construction.

 WSCC does not permit lime/cement stabilised material in capping or sub base layers.

 Block paviours shall be laid in herringbone pattern at 90° to the direction of travel.

Developer to ensure the permeable pavement is compatible with other undertaker requirements. i.e. Local Water Authorities & Statutory Undertakers.

Project Name

Section 278/38 Highway Agreement Standard Details

Drawing Title

Carriageway

Permeable Specification (Sheet 1 of 2)

A -	General update	MJA -		MJA -	15.03.19 -	
Rev	Revision details	Ch	kd	Appd	Date	
Drawı	n: MJA	MJA		For comment		
Chkd:		For tender		r		
Appd:		For construction		ruction		
Date:	<u> </u>	As constructed		ucted		

File ref: IWP Ref: County Hall, West Street Chichester West Sussex PO19 1RH (01243) 642105

Infrastructure Group

West Sussex County Council






Original Drawing Size : A3

Scale : As Shown Dimensions : Drawing No.

S278/38/30


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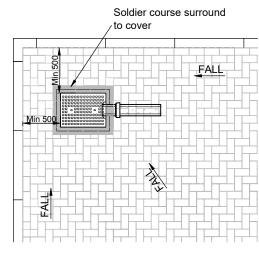


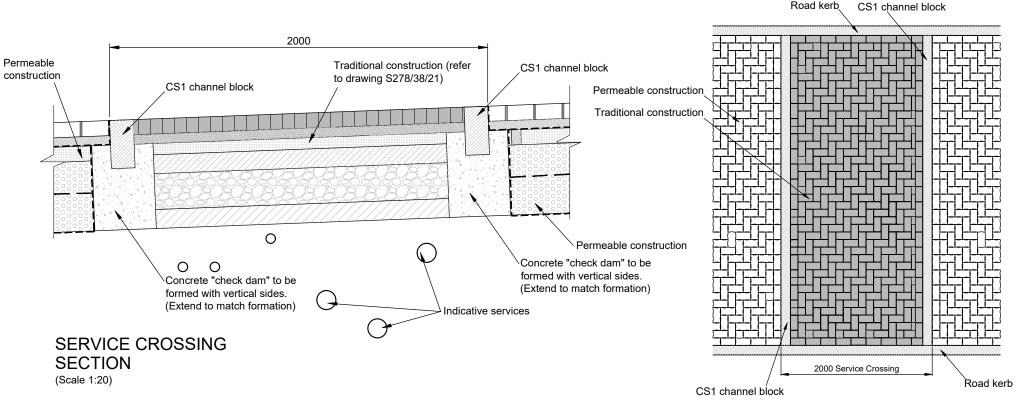

SERVICE CROSSING

Plan (Scale 1:50)



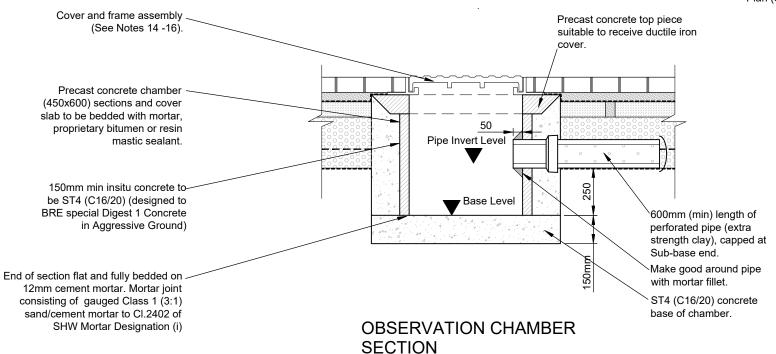

OBSERVATION CHAMBER TYPICAL PLAN LOCATION (Scale 1:50)

NOTE

- 1. Do not scale from this drawing.
- 2. Refer to drawings 02 & 03 for Approved Kerb Type Selection.
- 3. Refer to drawing 01 for laying methods.
- Prior to the commencement of laying the formation shall be treated with an approved residual weedkiller.
- The Highway Inspector may request inclusion of a non-woven separation membrane to mitigate weed/root intrusion.
- 6. Not suitable where 'no-dig' construction is required
- Asphalt Concrete to be in accordance with BS EN 13108-01 and BS 594987.
- Type 3 Sub-base to be in accordance with Specification for Highway Works clause 803.
- Block Paviours to be in accordance with BS EN 1338 and BS 7533-3:2005 (A1:2009).
- Total Carriageway construction depth must be greater than 450mm to negate susceptibility to frost penetration, irrespective of CBR value.
- 11. CBR values to be obtained from site investigation report and laboratory testing only. In-situ testing shall not be used to determine or amend the design CBR. The WSCC Inspector may request additional tests. In situ CBR tests shall only be used to confirm that the design CBR is met and to identify 'soft spots' in the construction.
- 12. WSCC does not permit lime/cement stabilised material in capping or sub base layers.
- 13. Block paviours shall be laid in herringbone pattern at 90° to the direction of travel, except where the WSCC Inspector has granted approval in writing to deviate from this requirement.
- Cover Grade shall be minimum D400 unless otherwise agreed with the Highway Inspector.
- 15. Manhole cover and frames shall comply with the relevant provisions of BS EN 124, BS 7903 and Highway Agency Guidance Document HA 104/02. They shall be of a non-rocking design which does not rely on the use of cushion inserts. All manhole covers shall be the non-ventilating type and shall have closed keyways.
- 16. Frames shall be bedded on a gauged Class 1 (3:1) sand/cement mortar to Cl.2402 of SHW Mortar Designation (i), and between 2 and 4 courses of Engineering Brickwork Class 'B' to BS EN 771-1:2011.

Developer to ensure the permeable pavement is compatible with other undertaker requirements. i.e. Local Water Authorities & Statutory Undertakers.

A -	General update	MJA -		MJA -	15.03.19 -
Rev	Revision details	Ch	kd	Appd	Date
Drawı	n: MJA	For comment		nent	
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Appd:		For co		r const	ruction
Date:		As constructed		ucted	

File ref: IWP Ref: West Sussex County Council Infrastructure Group

(Scale 1:20)

County Hall, West Street Chichester West Sussex PO19 1RH (01243) 642105



Project Name

Section 278/38 Highway Agreement Standard Details

Drawing Title

Carriageway

Permeable Specification (Sheet 2 of 2)

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10	March 2019
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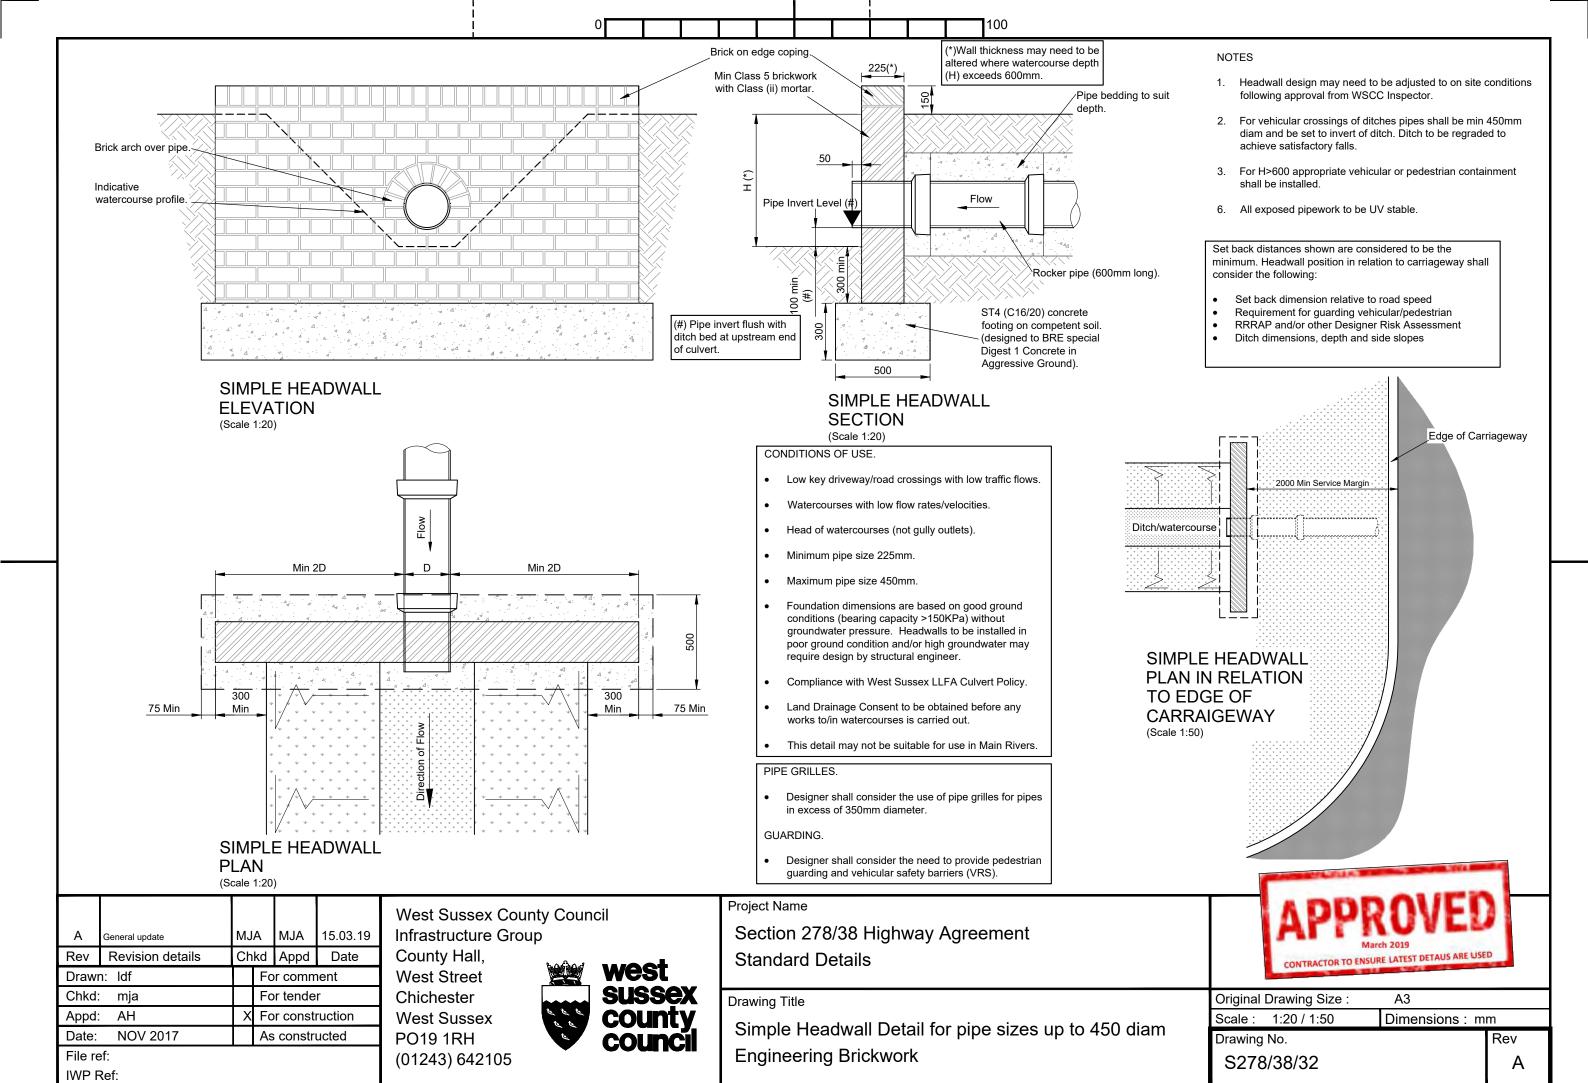
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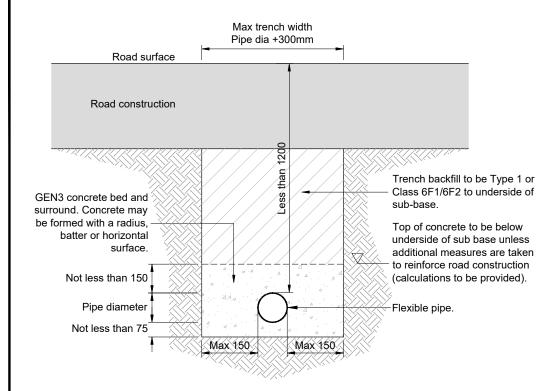
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Drawing No. S278/38/31 Rev


Α







150mm minimum concrete surround broken with 25mm thick compressible board at each joint. protect pipe from ingress of concrete by wrapping joint with polythene sheet and adhesive tape

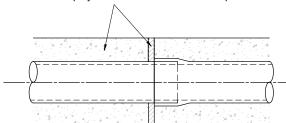

CONCRETE PIPE BEDDING AND SURROUND TYPE Z


(Depth of cover to pipe less than 1.2m)

NOTES

File ref:

IWP Ref:

- 1. Do not scale from this drawing.
- 2. Openings in existing highways shall be reinstated in accordance with the current version of Specification for Reinstatement of Openings in Highways published by HAUC.
- 3. Refer to drawing 11 for pipe selection.

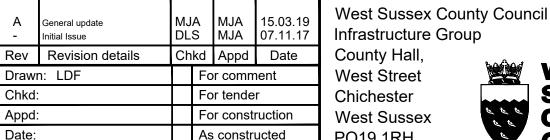

PO19 1RH

As constructed

(01243) 642105

Max trench width Pipe dia +300mm Road surface Road construction Trench backfill to be Type 1 or Class 6F1/6F2 to underside of sub-base. Processed granular material in accordance with table. Not less than 150 Pipe diameter Flexible pipe. Not less than 75 Max 150 Max 150

GRANULAR PIPE BEDDING AND SURROUND TYPE S

(Minimum depth of cover to pipe 1.2m)

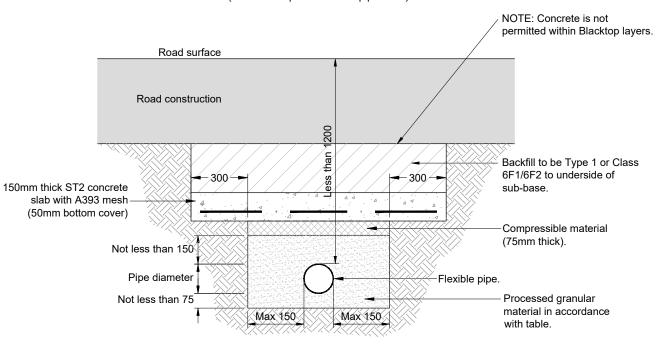


TABLE 1.

	TABLE 1.
Internal pipe dia (mm)	Bedding Material Size (mm)
150	10 or 14 nominal single size or 14 to 5 graded
Over 150 to 300	10, 14 or 20 nominal single size or 14 to 5 graded or 20 to 5 graded
Over 300 to 550	14 or 20 nominal single size or 14 to 5 graded or 20 to 5 graded
550 to 900	14 , 20 or 40 nominal single size or 14 to 5 graded or 20 to 5 graded or 40 to 5 graded
Over 900	STRUCTURES Pipes with a diameter of 0.9m or greater are classified as a structure and will be subject to review by the WSCC structures team.

To include aggregates to BS 882, air cooled blastfurnace slag, to BS1047 and lightweight aggregates to BS 3797 (Air cooled blastfurnace slag and lightweight aggregates not permitted for ductile iron pipes), recycled materials to BS8500-2.

Maximum CF value 0.15

For ferrous and cementitious pipeline materials sulphate content of bedding material must not be greater than 0.3% as sulphur trioxide

> Where drainage is installed in Filled ground the designer shall ensure measures are taken to control settlement.

Where drainage is installed in contaminated ground the designer shall provided specific details to be agreed with WSCC

Where drainage is installed in soft ground the designer shall ensure measures are taken to prevent migration of pipe bedding material in to the surrounding soil and vice versa.

Refer to Manual for Contract Documents for Highways Volume 3 - Highway Construction Details for pipelines installed under A roads

CONCRETE SLAB PIPE PROTECTION

(Depth of cover to pipe less than 1.2m and/or

Where top of concrete would encroach into the road construction sub-base layer)

Project Name

Section 278/38 Highway Agreement Standard Details

Drawing Title

Drainage

Pipe Bedding Details



Original Drawing Size: А3


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Drawing No.

S278/38/33

Α



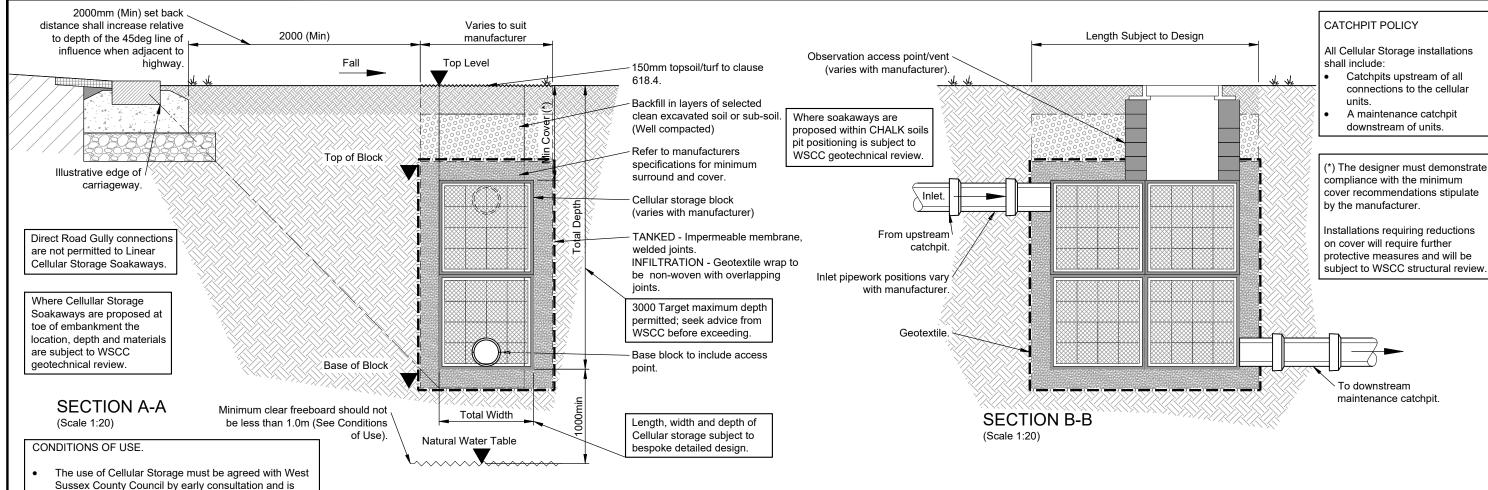

NOTES

- Do not scale from this drawing.
- The design criteria shall be agreed with WSCC. Drainage strategy and flood risk reports shall be provided. In the absence of this information the designer shall ensure compliance as follows:
- Site Investigation Report.
- Infiltration Test Results.
- Design Calculations in accordance with BRE365 or CIRIA 156.
- Design for 1:100yr Return Period and include an allowance for climate change.
- Environment Agency consent.

West Sussex County Council

Infrastructure Group

County Hall,

- 6. Cellular Soakaways to be sited clear of the footways and service margins in order to avoid obstructing the route of public utilities.
- Ground water monitoring may be necessary to establish highest seasonal variation. Where 1m of unsaturated ground below a Cellular soakaway cannot be achieved, seek advice from WSCC.
- Easement will be required where Cellular soakaways are located outside of Public Highway.
- 9. Tanked Cellular storage shall be vented separately (not into catchpits).

Example Cellular Storage Schedule (to be included on design drawings)

Cellular Soakaway No.	Catchment Area (m2)	Soakaway Top Level (m)	Soakaway Base Level (m)	Length (m)	Width (m)	Incoming Pipe Invert (m)	Total Depth (m)
PIT#	###	###	###	###	###	###	###

ALL LEVELS SHOULD BE RELATED TO ORDNANCE SURVEY DATUM.

A -	General update Initial Issue	MJ DL		MJA MJA	15.03.19 07.11.17
Rev	Revision details	Ch	kd	Appd	Date
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Chkd:			Fo	r tende	r
Appd:			Fo	r const	ruction
Date:			As	constr	ucted

subject to site suitability including but not limited to the

Cellular Storage is permitted as 'Tanked' or 'Infiltration'

A relevant geotechnical assessment must be provided

including infiltration testing at a depth commensurate

with formation level in subsoil and ground water level

The soil infiltration rate must be better than 1x10-7m/s.

Minimum 1m freeboard from formation to highest

or proposed structures (greater distance may be

required in CHALK soils, seek advice from

Units to be BBA and/or HAPAS approved.

Unit strength calculations to be provided.

Soakaways to be positioned at least 5m from existing

monitoring during the wet winter period (October to

March).

groundwater level.

geotechnical consultant).

Locations within verges only.

File ref: IWP Ref: r comment West Street
Chichester
r construction West Sussex
Constructed PO19 1RH
(01243) 642105



Project Name

Section 278/38 Highway Agreement Standard Details

Drawing Title

Drainage

Cellular Storage (Sheet 1 of 2)

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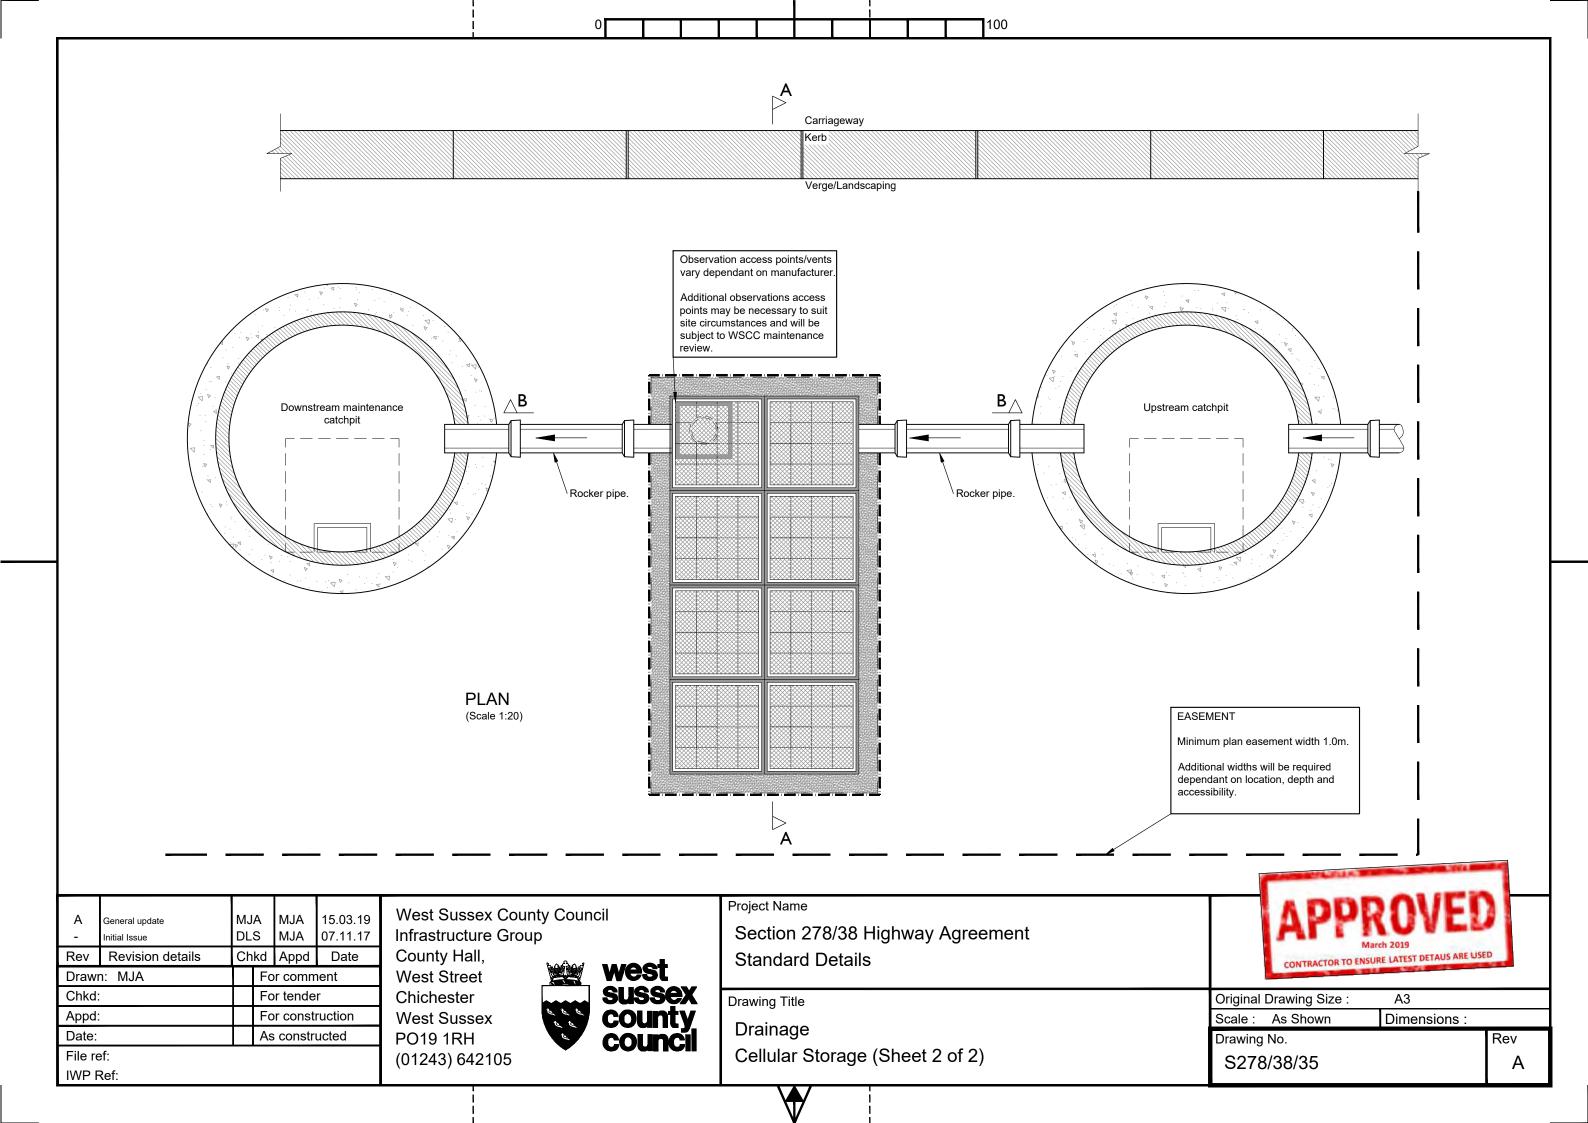
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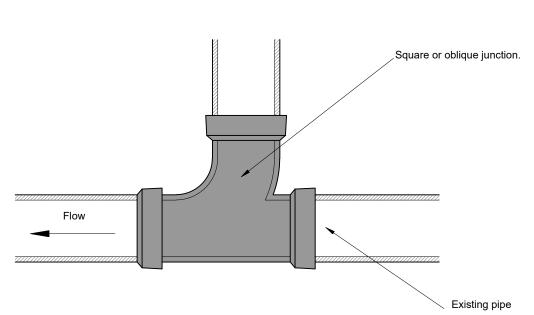
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Drawing No. S278/38/34


Rev A








CONNECTION TO SAME SIZE DIAMETER PIPE (PLAN) (1:10)

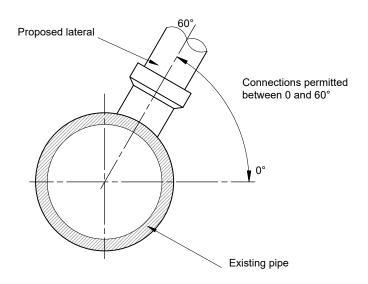

ACCEPTABLE CONNECTION LOCATION (SECTION)

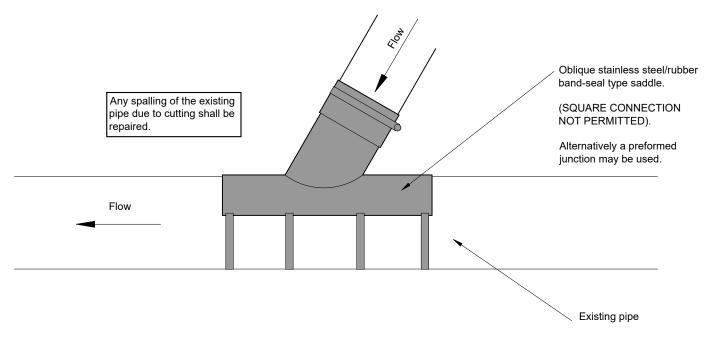

CONNECTION TO AN EXISTING LARGER DIAMETER SMOOTH WALL PIPE (PLAN)

(1:10)

Saddles where the connecting lateral protrudes or has the potential to protrude in to the main pipe will not be permitted.

Connections of pipes of the same diameter must be made using preformed junctions at greater than 90 deg to the main flow

Connections between new pipes shall be made using preformed junctions. Saddles will not be permitted to connect new laterals to new pipelines.

Condition of existing pipe to which the connection is proposed shall be assessed. If the existing pipe is damaged a sufficient length (as directed by the highway inspector) shall be replaced to ensure a satisfactory connection.

Where pipeline are installed in contaminated soil the designer shall ensure that material specified are resistant to any chemicals that may be present.

NOTES

- 1. Do not scale from this drawing.
- Openings in existing highways shall be reinstated in accordance with the current version of Specification for Reinstatement of Openings in Highways published by HAUC.

A -	General update Initial Issue	MJ DL		MJA MJA	15.03.19 07.11.17
Rev	Revision details	Ch	kd	Appd	Date
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Appd:			Fo	r const	ruction
Date:			As	constr	ucted

File ref: IWP Ref: West Sussex County Council
Infrastructure Group

County Hall, West Street Chichester West Sussex PO19 1RH (01243) 642105



Project Name

Section 278/38 Highway Agreement Standard Details

Drawing Title

Drainage Lateral Connections

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Drawing No. S278/38/36

Rev A

